## RECOVERY CENTERS OF AMERICA

# BILLINGSLEY FACILITY BUILDING 3

11,100 BILLINGSLEY ROAD WALDORF, MD 20602

### **OWNER**

**DRAWING LIST** 

SHEET | SHEET LIST

A-0.0 | COVER SHEET

A-0.1 INFORMATION SHEET

**ARCHITECTURAL DRAWINGS** 

A-1.0 | ARCHITECTURAL PLAN BUILDING 3

A-1.3 RCP & CEILING HEIGHTS BUILDING 3

A-4.1 WALL FLASHING & SIDING DETAILS

A-3.0 ARCHITECTURAL SECTIONS

A-3.1 | ARCHITECTURAL SECTIONS

A-4.2 FOLDING PARTITION DETAILS

A-6.0 WINDOW SCHEDULES

A-6.1 DOOR SCHEDULES

A-6.2 DOOR HARDWARE

A-0.2 | EGRESS PLANS & CODE COMPLIANCE - BLDG 3

A-1.2 TOILET RM. PLANS & ELEVATIONS BUILDING 3

A-2.0 ARCHITECTURAL ELEVATIONS BUILDING 3

A-4.0 FLASHING, ROOFING & PARTITION DETAILS

SHEET | SHEET LIST

● | ● | ● | ● | I-8.01 | INTERIOR CEILING DETAILS

● ● S-0.0 COVER SHEET

● ● ● ○ S-0.2 PROJECT SCHEDULES

● | ● | ● | ● | I-8.1 | INTERIOR ELEVATIONS AND DETAILS

S-0.1 GENERAL NOTES

● ● ● ● S-5.3 FOUNDATION AND FRAMING SECTIONS

INTERIOR DRAWINGS

I-1.1 INTERIOR FINISH PLAN

I-1.2 INTERIOR FURNITURE PLAN

• I-1.0 INTERIOR FINISH SCHEDULE AND DETAILS

REFLECTED CEILING PLANS

I-8.2 INTERIOR ELEVATIONS AND DETAILS

STRUCTURAL DRAWINGS

MECHANICAL DRAWINGS

H-0.0 HVAC INFORMATION SHEET

PLUMBING DRAWINGS

P-1.0 | PLUMBING FIRST FLOOR PLAN

P-0.0 | PLUMBING INFORMATION SHEET

ELECTRICAL DRAWINGS E-0.0 ELECTRICAL INFORMATION SHEET

E-1.1 | ELECTRICAL ROOF PLAN

FIRE PROTECTION DRAWINGS

FP-0.0 | FIRE PROTECTION INFORMATION SHEET

FP-1.0 | FIRE PROTECTION FIRST FLOOR BUILDING

E-1.0 | ELECTRICAL FIRST FLOOR PLAN - POWER & SIGNAL

E-2.0 | ELECTRICAL FIRST FLOOR PLAN - LIGHTING

E-3.0 | ELECTRICAL SCHEDULES AND DETAILS

● ● S-1.0 BLDG 3 - FOUNDATION & ROOF FRAMING PLANS

S-5.2 TYPICAL FRAMING DETAILS

S-5.1 TYPICAL FOUNDATION DETAILS

H-1.0 HVAC FLOOR PLAN

H-2.0 HVAC SCHEDULES

H-3.0 HVAC DETAILS

PLUMBING FIXTURE / ACCESSORIES SCHEDULE

2700 RENAISSANCE BLVD. KING OF PRUSSIA, PA 19406 CONTACT: JOHN LOMBARDO

PHONE: (610) 239-6100

### **ARCHITECT**

### THOMAS E HALL & ASSOCIATES, INC.

## STRUCTURAL ENGINEER

MACINTOSH ENGINEERING 32191 NASSAU ROAD - UNIT 2

LEWES, DE 19958 CONTACT: JAMES BAKER, P.E.

• • • •

• • • • •

• • • • •

• • • • •

• • • • •

• • • •

 $\bullet$  |  $\bullet$  |  $\bullet$  |  $\bullet$ 

 $\bullet$  |  $\bullet$  |  $\bullet$  |  $\bullet$ 

SHEET | SHEET LIST

(302) 448-2000

### MEP/FIRE PROTECTION ENGINEER

SHEET | SHEET LIST

BSEG, LLC

### INTERIOR DESIGNER

## **BALONGUE DESIGN**

707 MATSONFORD ROAD VILLANOVA, PA 19085 CONTACT: BARBARA A. BALONGUE

PHONE: 610-525-7593 EXT. 20


E-MAIL: barbara@balongue.com

**DRAWING LIST - CONT'D.** 

**LOCATION MAP** 



11,100 BILLINGSLEY

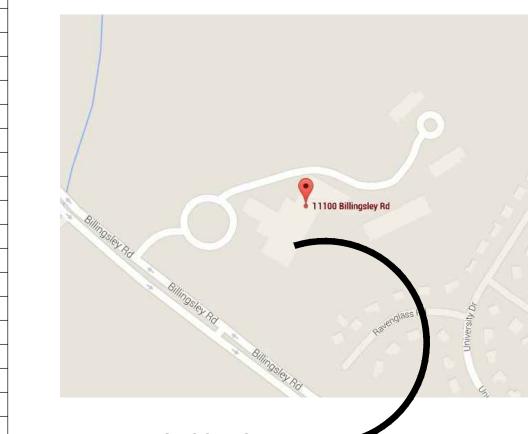


DRAWING ISSUE LEGEND

REVISIONS TO DRAWING / ISSUED DRAWINGS

O NO REVISIONS TO DRAWING

11,100 BILLINGSLEY



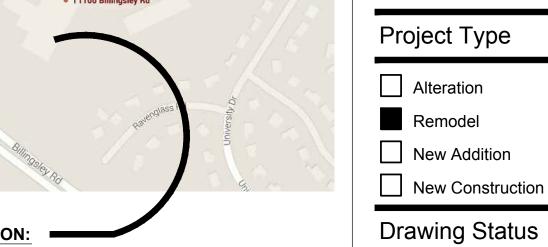

Design Phase
Not For Construct

For Pricing

For Construction

No.	Date	Description
19	06/03/2016	REVISION #10
$\overline{\mathbb{A}}$	07/07/2016	REVISION #11
12	07/27/2016	REVISION #12
13	09/16/2016	REVISION #13
14	01/06/2017	REVISION #14
14.1	02/03/2017	ADDENDUM #1

17 FEB 03 AS NOTED

COVER

SHEET Sheet No:

RECOVERY CENTERS OF AMERICA

**DRAWING LIST - CONT'D** 

240 CONESTOGA ROAD **WAYNE**, PA 19087 CONTACT: TOM HALL

4949 LIBERTY LANE - SUITE 115 ALLENTOWN, PA 18106 CONTACT: AHMAD MAHMUD, P.E.

PHONE: (610) 351-8225

# **DRAWING LIST - CONT'D**

Recovery Centers of America

**BILLINGSLEY** 

**FACILITY** 

**BUILDING 3** 

Wayne, Pa 19087

www.teh-architects.com

11,100 BILLINGSLEY

MARYLAND 220602

**ROAD WALDORF** 

New Addition

**Drawing Status** 

■ Not For Construction

For Permit


Revision

Revisions

**Drawing Title:** 

A-0.0

Copyright © by Thomas E. Hall & Associates, Inc., Wayne, PA 19087, Phone number (610) 293-9900. All rights reserved.

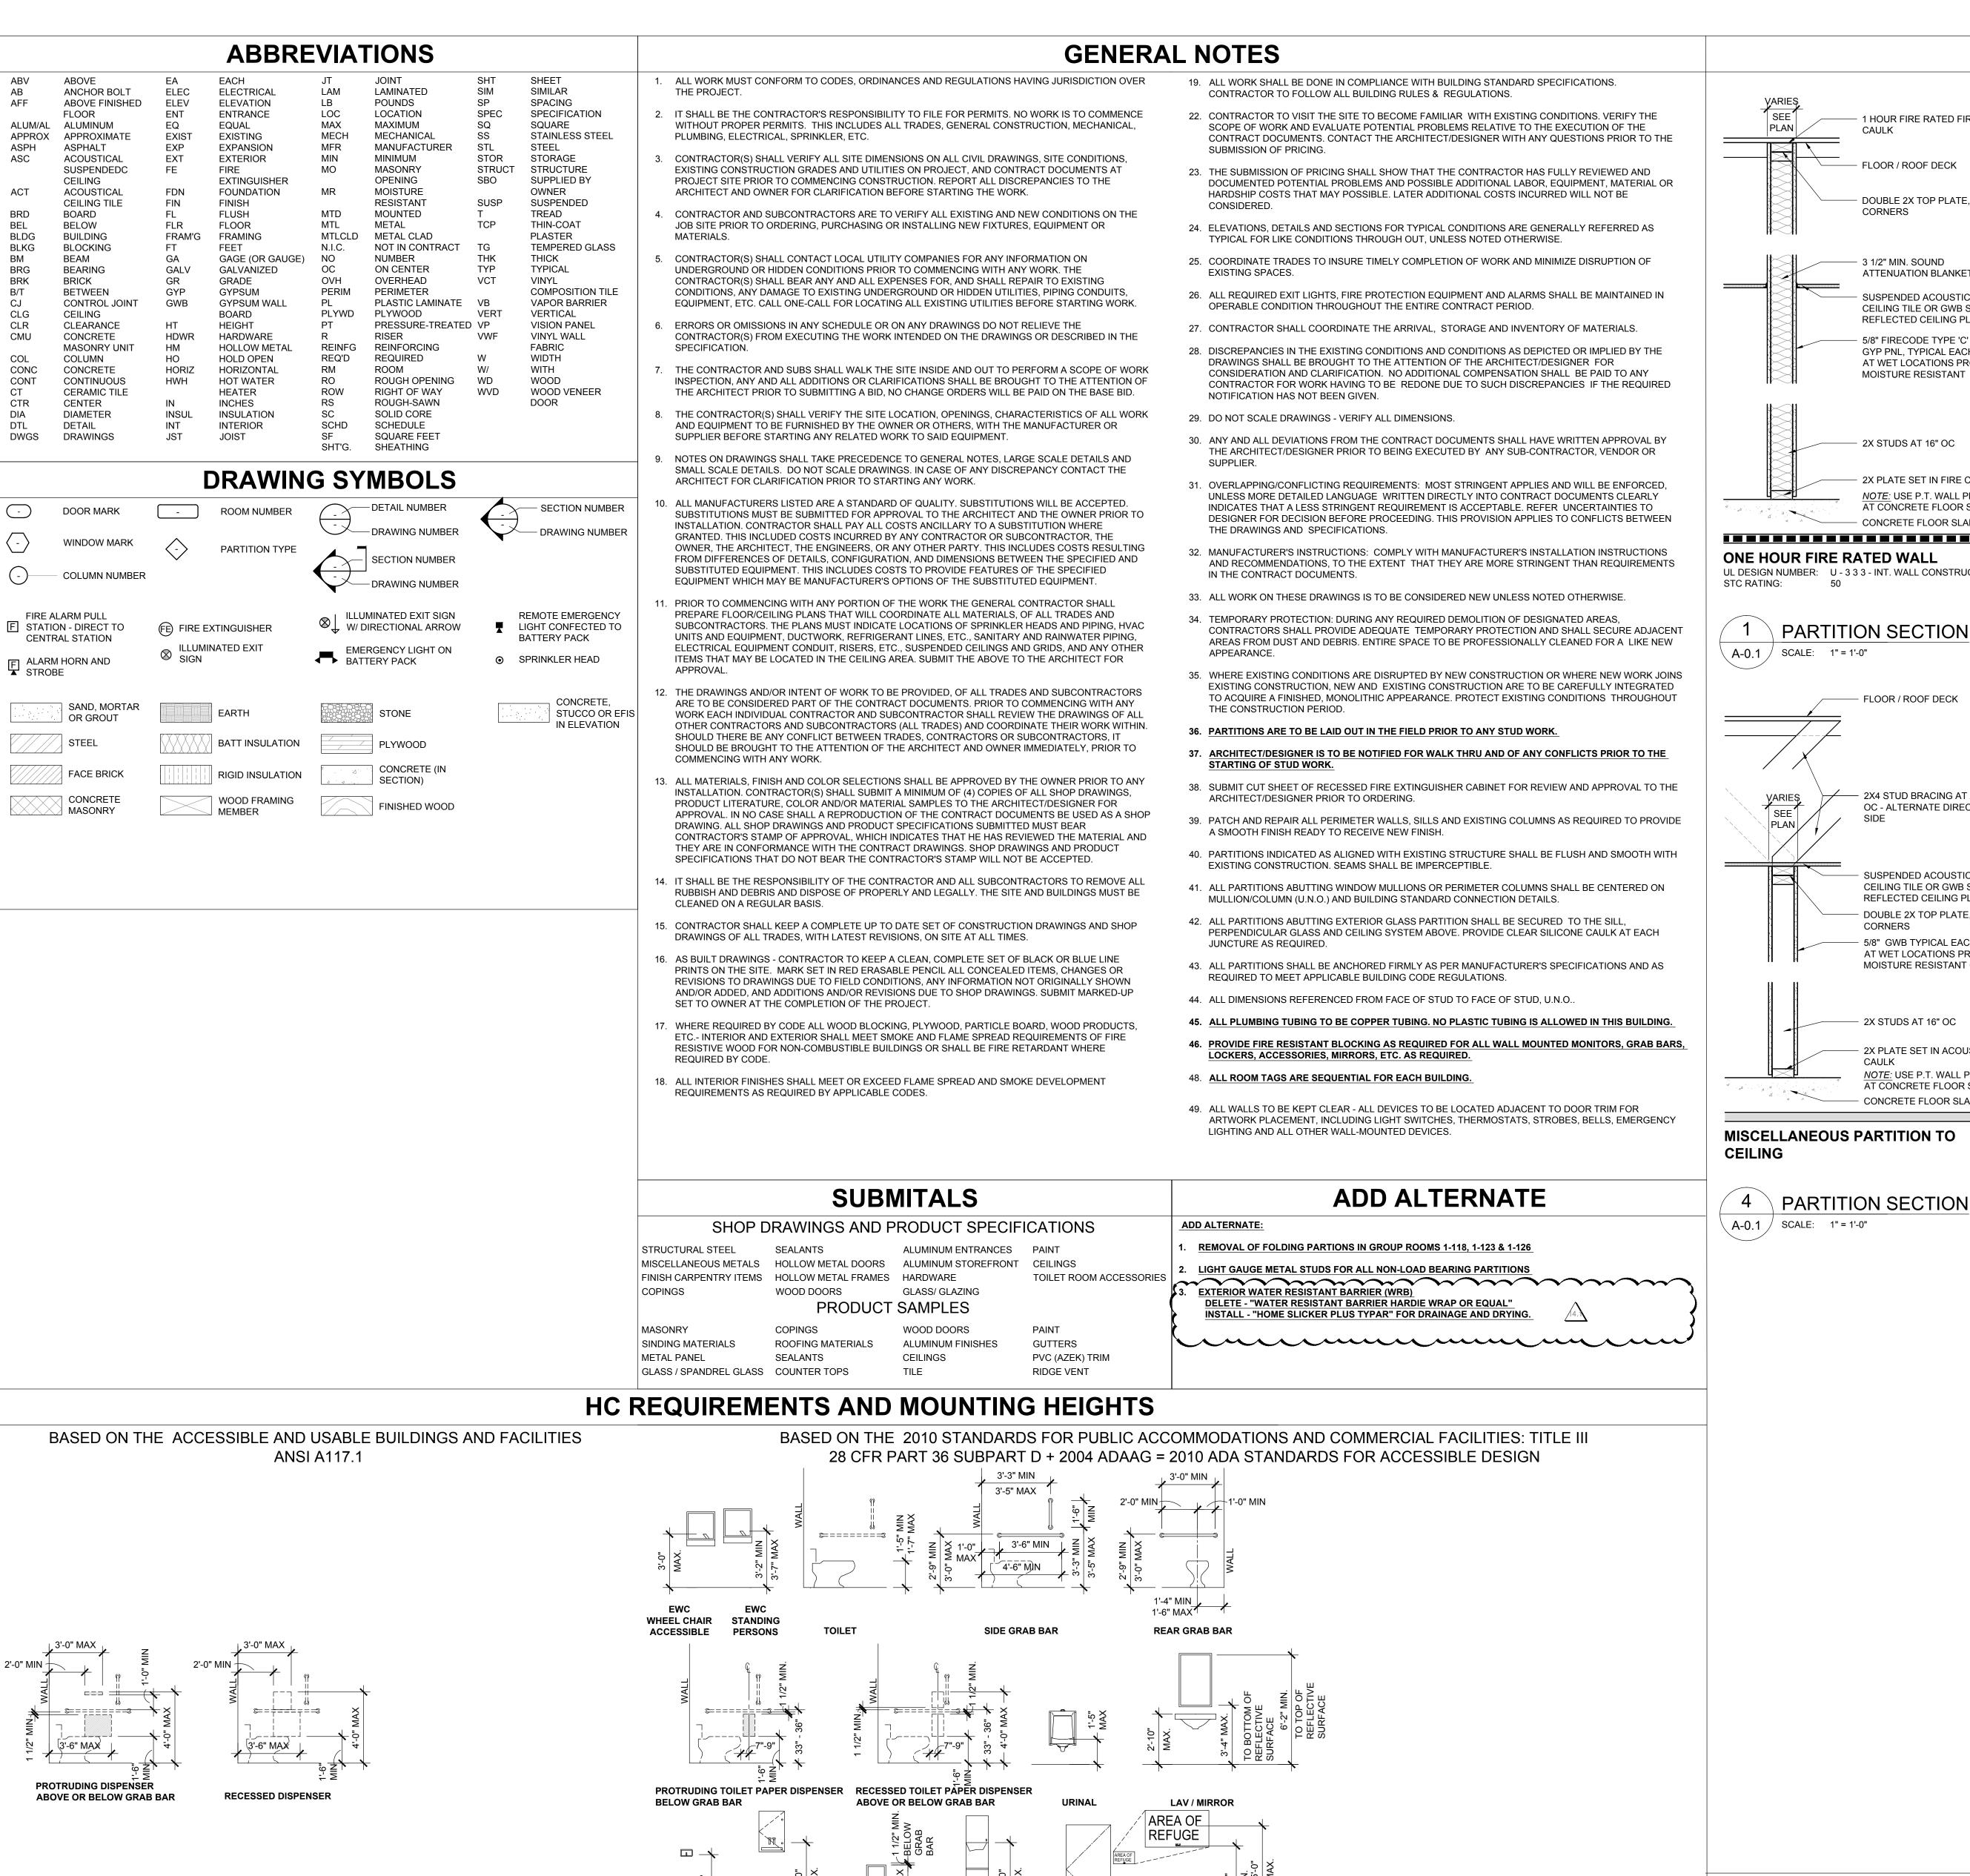

SANITARY

DISPENSER

**PICTOGRAM** 

NAPKIN VENDOR DISPOSAL (HC)

INTERNATIONAL

**ACCESSIBILITY** 

SIGN OF

SANITARY NAPKIN TOWEL DISPENSER/


DISPOSAL

**TACTILE SIGN** 

**LOCATION HEIGHT** 

**TACTILE SIGN** 

COAT HOOK HEIGHT TOWEL HOLDER HGT.

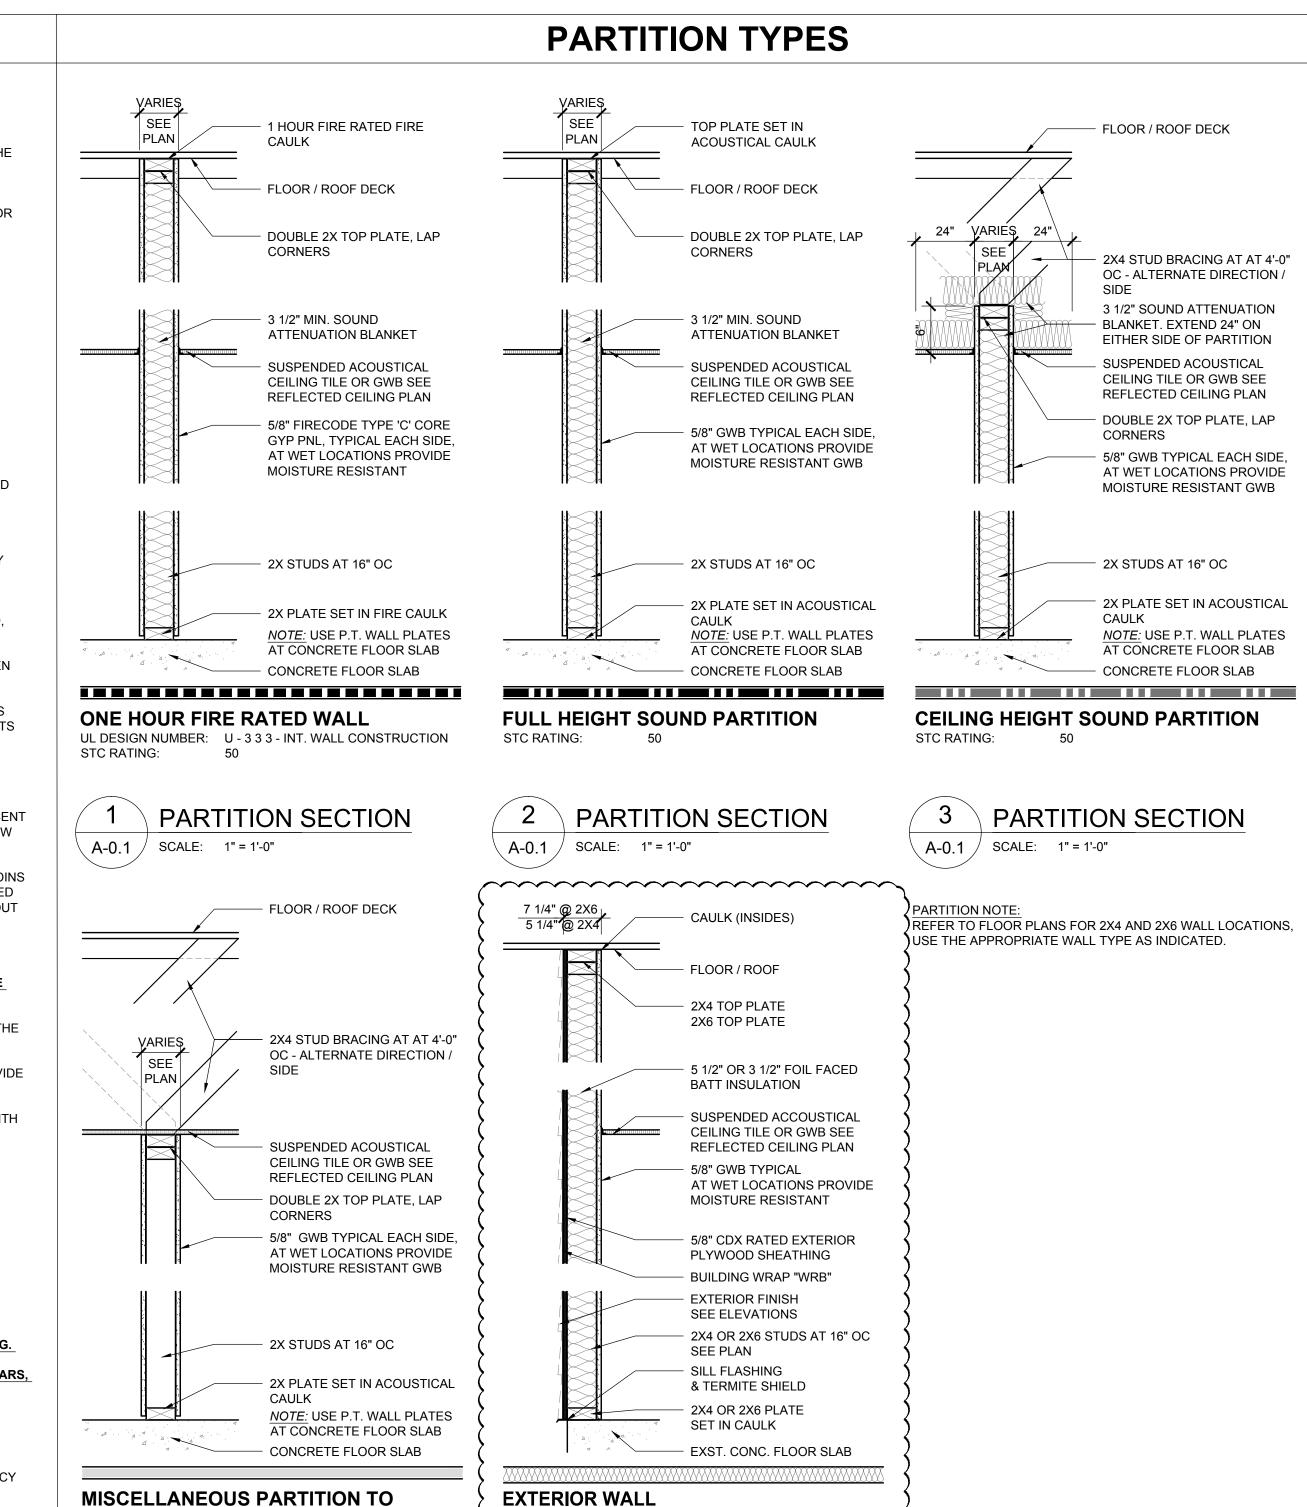

5 PARTITION SECTION

A-0.1 / SCALE: 1" = 1'-0"



## PARTITION NOTES

- 1. SEE FINISH SCHEDULE AND DETAILS FOR PARTITION FINISHES, TRIM, BASE TYPE, ETC.
- 2. ALL PARTITIONS ARE SUBJECT TO LIMITING HEIGHT DETERMINED BY STUD SIZE, STUD GAUGE, AND/OR LATERAL BRACING.
- B. FIRE RATED PARTITIONS TO RUN FROM FINISH FLOOR TO UNDERSIDE OF ROOF OR FLOOR DECK. SEAL ALL VOIDS AND/OR PENETRATIONS WITH CLASS I MATERIAL AS REQUIRED BY FIRE RATING UNDERWRITER. FIRE RATED PARTITIONS SHALL RUN OVER DOORS AND/OR BORROWED LIGHT OPENINGS.
- 4. DOORS WITHIN ALL RATED PARTITIONS ARE TO BE RATED IN COMPLIANCE TO WALL
- PROVIDE ACOUSTICAL SEALANT AT ALL PARTITIONS WHICH CONTAIN SOUND ATTENUATION BLANKETS, SET BOTTOM PLATE IN TWO CONTINUOUS BEADS OF SEALANT.




Project

BILLINGSLEY
FACILITY
BUILDING 3
11,100 BILLINGSLEY
ROAD WALDORF,
MARYLAND 220602

ARCHITECTS

Thomas E Hall & Associates, Inc 240 Conestoga Road Wayne, Pa 19087 (610) 293-9900 www.teh-architects.com Architecture • Interiors • Planning

Seal

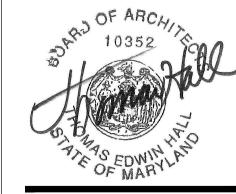

THESE DRAWINGS ARE PRELIMINARY AND NOT OFFICIAL UNTIL SIGNED AND SEALED.
CONTRACTOR SHALL VERIFY DIMENSIONS AND SITE CONDITIONS AND REPORT ANY DISCREPANCIES TO THE ARCHITECT. THE ARCHITECTS IS NOT RESPONSIBLE FOR ANY UNREPORTED DISCREPANCIES.

Consultant

Key Plan

BLDG #6

BLDG #5

BLDG #

BLDG #

Project Type

Alteration

Remodel

New Addition

New Construction

Drawing Status

Design Phase

Not For Construction
For Pricing

For Permit
Revision

Revisions

For Construction

No. Date Description

06/03/2016 REVISION #10

07/07/2016 REVISION #11

07/27/2016 REVISION #12

09/16/2016 REVISION #13

01/06/2017 REVISION #14

02/03/2017 ADDENDUM #1

Job No: 6142.00
Drawn By:

Checked By: TEH
Date: 17 FEB 03
Scale: AS NOTED
Drawing Title:

INFORMATION

eet No:

CODES

ADOPTED CODES FOR USE IN THE STATE OF MARYLAND CHARLES COUNTY - EFFECTIVE 3 AUG 2015

2015 INTERNATIONAL BUILDING CODE CHARLES COUNTY BUILDING CODE (COMAR 05.02.02) MARYLAND ACCESSIBLE CODE GUIDELINES FOR BUILDINGS AND FACILITIES - 2012 2010 ADA STANDARDS FOR ACCESSIBLE DESIGN

2015 NFPA 101 LIFE SAFETY CODE 2015 NFPA 220 STANDARD ON TYPES OF BUILDING CONSTRUCTION 2015 INTERNATIONAL ENERGY CODE 2015 INTERNATIONAL EXISTING BUILDING CODE 2015 INTERNATIONAL MECHANICAL CODE 2015 INTERNATIONAL PLUMBING CODE 2015 INTERNATIONAL FUEL GAS CODE 2015 INTERNATIONAL FIRE CODE 2013 NFPA 13 - SPRINKLER SYSTEMS

2014 NATIONAL ELECTRIC CODE NFPA 70

SIGNALING CODE

2013 NFPA 72 - NATIONAL FIRE ALARM AND

2 APPLICABLE CODES A-0.2 SCALE: NO SCALE

CODE OFFICIAL CONTACT MARYLAND CODES ADMINISTRATION **ED LANDON** 

EGRESS PLAN - BUILDING THREE

A-0.2 SCALE: 1/16" = 1'-0"

DIRECTOR OF CODE ADMINISTRATION 100 COMMUNITY PLACE CROWNSVILLE, MD 21032 (410) 514-7444 landon@mdhousing.org STATE FIRE MARSHALL **WILLIAM E. BARDARD** 1201 REISTERSTWON ROAD PIKESVILLE, MD 21208 (410) 653-8980 SFMO@mdsp.org

3 CODE OFFICALS A-0.2 SCALE: NO SCALE


BUILDING 3 - FIRST FLOOR				6,416 SF	1	336 OCC
OUT-PATIENT						6,416 SF
LOUNGE GROUP ROOMS REMAINING SPACE	895 SF 1,656 SF 3,865 SF	ΑT	007			60 OCC 237 OCC 39 OCC
TOTAL OCCUPANTS						336 OCC
FIXTURE		R	EQL	JIRED	Р	ROVIDED
TOILET VISITOR 297 OCC / 1 75 OCC STAFF 39 OCC / 1 WO	-			4 WC 2 WC		6 WC
LAVATORIES VISITOR 297 OCC / 1 100 OCC STAFF 39 OCC / 1 LA				3 LAV 2 I AV		4 I AV
DRINKING FOUNTAIN SERVICE SINK				EWC 1 SS		1 EWC 1 SS

DESIGN OCCUPANT LOAD AND 4 REQUIRED PLUMBING FIXTURES A-0.2 SCALE: NO SCALE

Code Chapter	NFPA 101 - 2015 Required	IBC 2015 Required	Provided	Comment
Use Group/Ocupancy	Chapter 32 - New Residential Board and Care Occupancies - Large Facility	I-1 (308.3) In-Patient Areas Condition 1	I-1, Condition 1 Residential Board & Care - Large Facility	Buildings used for Drug and Alcohol Treatment Centers, Occupants are capable of responding to emergency situation with-out physical assistance from staff.
Special requirements based on use & occupancy I-1		Separation Walls - between sleeping units and corridor walls are to be fire partitions in accordance to (709)	Yes	
		Horrizontal separation in accordance with (712)		
General building heights and areas				
Existing / New Building Area and Height				
Building 3 - First Floor	V (000) / 1 St	15,750 SF / 3 St	6,416 SF - One Story	I - 1 Use, V-B Construction
Total Building Square Footage		[13,500 + (4,500 x 0.5)] x 1 = 15,750 SF	6,416 SF	
Incidental accessory occupancy		See (Table 509)	Fire Rated Per	
Construction Type	V (000) (Table 32.3.1.3)	5 B (Table 506.2)	5 B (Table 506.2)	
Primary Structure	0 Hr	0 Hr	0 Hr	
Bearing walls interior or exterior	0 Hr	0 Hr	0 Hr	
Non bearing walls exterior	0 Hr	0 Hr (Table 602), >10 feet	0 Hr	
Non bearing walls and partitons interior	0 Hr	0 Hr	0 Hr	
Floor Construction and Secondary Members	0 Hr	0 Hr	0 Hr	
Roof Construction and Secondary Members	0 Hr	0 Hr	0 Hr	
Fire Partitions / Barriers	1 Hr	1 Hr (709.3)	1 Hr	I-1 In- Patient Areas
Flame Spread Index		<25		
Fire and smoke protection				
Fire Door - 1 hr Fire Rated Wall	3/4 Hr	1 Hr	1 Hr	
Fire Door - 1 hr Fire Rated Corridor Wall	1/3 Hr	1/3 Hr	1/3 Hr	Corridor Walls
Interior finishes				
Exit Enclosures and Passage Ways	Class A / Floor - Class II	Class B (Table 803.11)	Class A	
Corridors	Class B / Floor - Class I or II	Class C (Table 803.11)	Class B	
Rooms and Enclosed spaces	Class B / Floor - Class I or II	Class C (Table 803.11)	Class B	
Contents and Furnishings	Section 10.3 (10.3.1 thru 10.3.9.2)		Provided per NFPA (10.3)	
Fire protection systems				
Sprinkler System	Required (32.2.3.5.3) - NFPA 13	Required (903.2.6) - NFPA 13R	Provide per NFPA 13	
Portable fire extinguishers	Required (9.9)	Required (906.1)	Provide per NFPA 101 Sec (9.9)	
Fire Alarm & Detection system	Required (9.6) & (32.3.3.4)	Required (907.2.6.1 & 907.2.6.2)	Provide per NFPA 101 Sec 9.6. & 32.3.3.4	
Means of egress				
Design Occupant Load - Building 3 First Floor	336 Occupants	336 Occupants	See Occupant Tables	
Egress Width -Building 3 First Floor	Other Componets: 336 x .20" = 67.2" Min	Other Componets: 336 x .20" = 67.2" Min	170" Provided	
Corridor wall rating	1/2 Hr (32.3.3.6.2)	1/2 Hr (711.2.4.3 Exception 1)	1/2 Hr	
Maximum Exit Travel Distance	200', Sprinklers Provided	250', Sprinklers Provided (Table 1017.2)	<200'	
Means of egress illumination	1 FC Min Typical / 10 FC Stairs	Required 24 hrs./ day. 1 FC Min	Provide per NFPA (7.8.1.3)	Illumination required during power failure
Special locking arrangements	Permitted (7.2.1.6.1.1)	Permitted (1010.1.9.7(1) thru (8)	Provide per NFPA (7.2.1.6.1.1)	Delayed-Egress Locking Systems
Exit signs	Located / Lighted per (7.10)	Located per (Section 1013)		
Exit through intervenening spaces	Allowed through accessory spaces, but must provide a discernable path of egress travel through that space.	Allowed through accessory spaces, but must provide a discernable path of egress travel through that space.		

5 2015 NFPA AND IBC 2015 CODE REQUIREMENTS - BUILDING 3 A-0.2 SCALE: NO SCALE


- SPRINKLER SHOP DRAWINGS AND FIRE ALARM SHOP DRAWINGS TO BE SUBMITTED TO THE FIRE MARSHALL

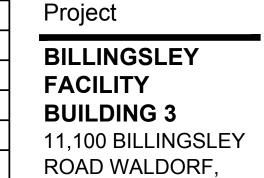

Recovery Centers of America


MARYLAND 220602

Thomas E Hall & Associates, Inc. 240 Conestoga Road Wayne, Pa 19087 (610) 293-9900 www.teh-architects.com Architecture • Interiors • Planning

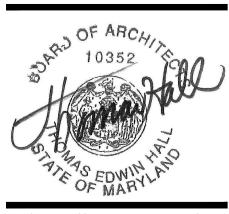

THESE DRAWINGS ARE PRELIMINARY AND NOT OFFICIAL UNTIL SIGNED AND SEALED.
CONTRACTOR SHALL VERIFY DIMENSIONS AND SITE CONDITIONS AND REPORT ANY DISCREPANCIES TO THE ARCHITECT. THE ARCHITECTS IS NOT RESPONSIBLE FOR ANY UNREPORTED DISCREPANCIES.

Consultant

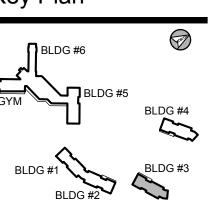

Project Type Alteration Remodel New Addition New Construction

**Drawing Status** Design Phase

Not For Construction

For Pricing For Permit

Revision For Construction

Revisions


No. Date 06/03/2016 REVISION #10 07/07/2016 REVISION #11 07/27/2016 REVISION #12 09/16/2016 REVISION #13 01/06/2017 REVISION #14 02/03/2017 ADDENDUM #1


Job No: 6142.00 Drawn By: Checked By: TEH Date: 17 FEB 03 Scale: AS NOTED Drawing Title:

EGRESS PLANS & CODE COMPLIANCE

Sheet No:


A-0.2

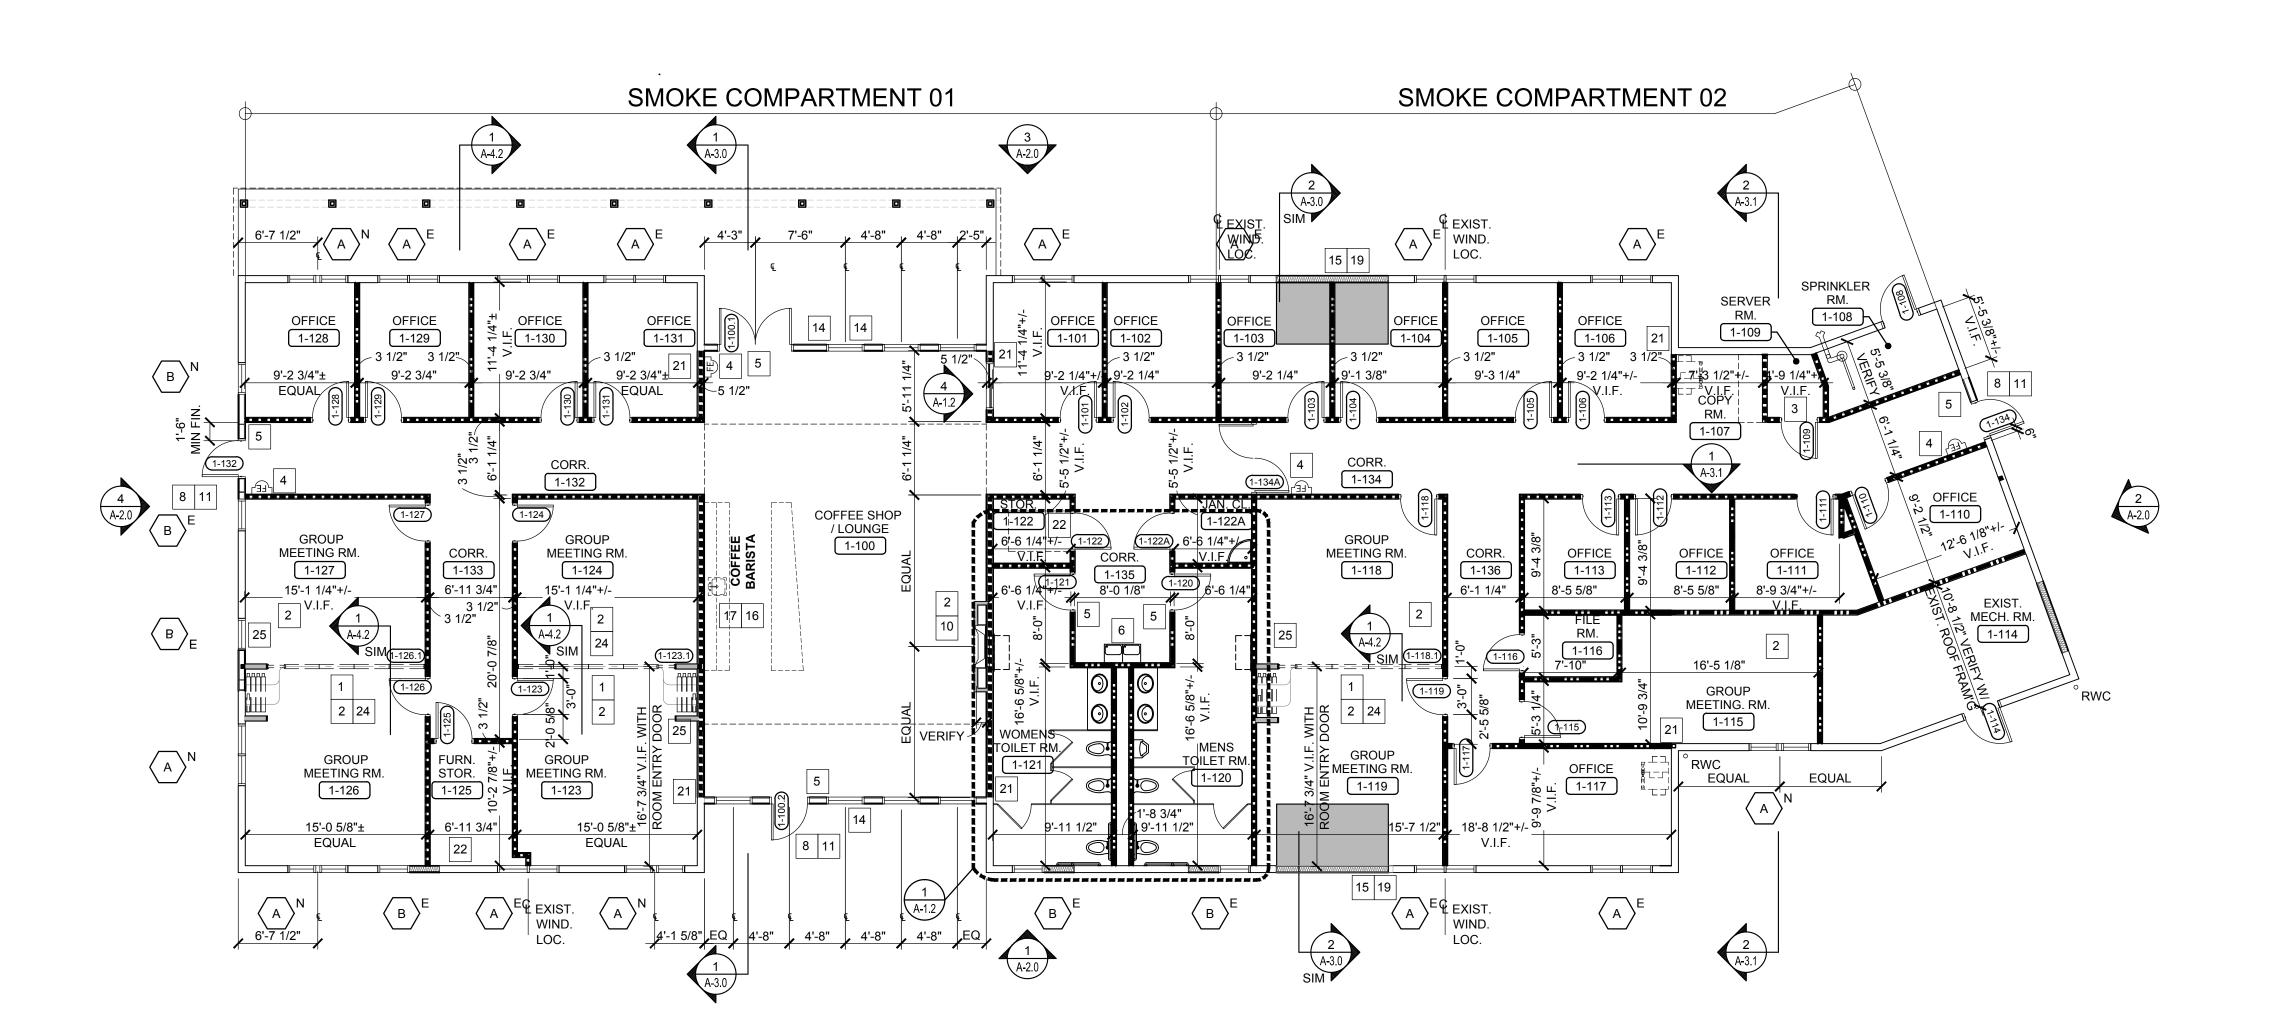


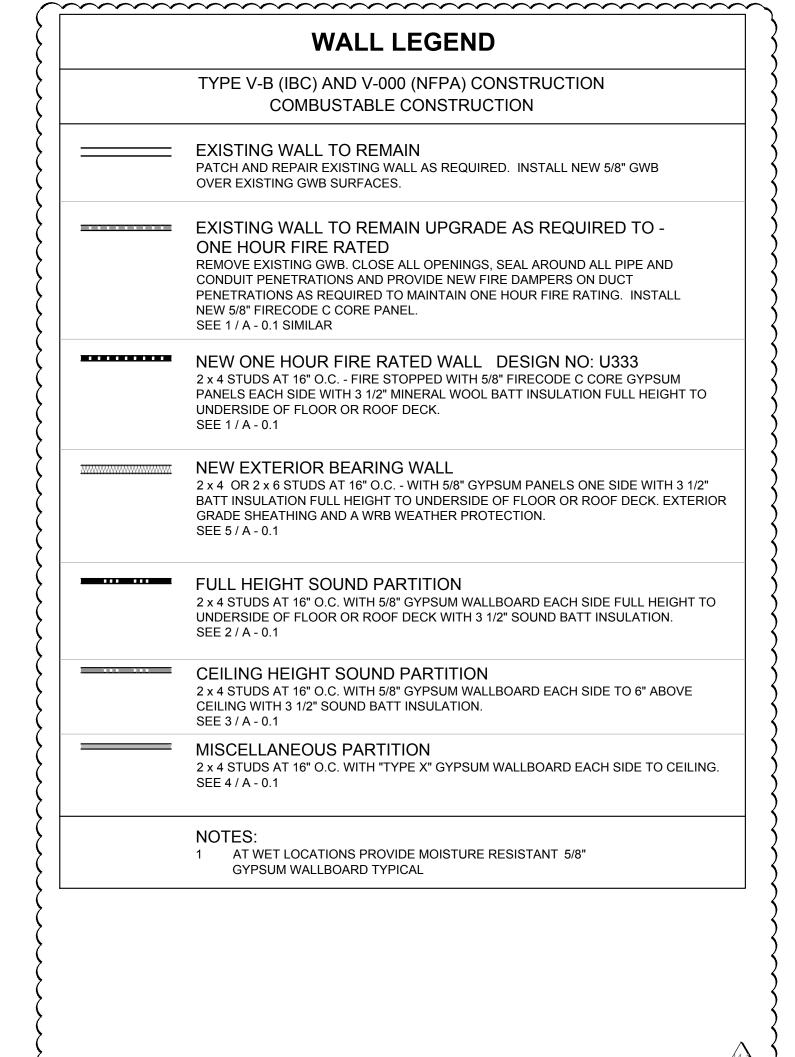

### ARCHITECTURAL ROOF PLAN KEY NOTES GC TO VERIFY ALL EXISTING ROOF SLOPES, TYPICAL GC TO VERIFY ALL EXISTING ROOF DRAINS AND LOCATIONS, TYPICAL GC TO VERIFY ALL EXISTING EQUIPMENT, CURBS & LOCATIONS TYPICAL FULLY ADHERED SINGLE PLY TPO ROOFING OVER TWO 2" LAYERS OF POLYISO RIGID ROOF INSULATION WITH ALL JOINTS STAGGERED INSTALL PER ( MANUFACTURERS SPECIFICATIONS (MIN. SLOPE OF 1/4" PER FOOT) ASPHALT SHINGLE ROOFING 30 YEAR MINIMUM WARRANTY INSTALL PER MANUFACTURERS SPECIFICATIONS ROOF TOP EQUIPMENT LOCATION SEE MECHANICAL DRAWINGS INSTALL PER MANUFACTURERS SPECIFICATIONS TYPICAL INSTALL NEW ROOF FRAMING, SHEATHING, INSULATION & ROOFING AT INFILL ADDITION AREAS SEE STRUCTURAL DRAWINGS GC TO VERIFY IF EXISTING RIDGE VENT(S) ON ROOF ARE IN SATISFACTORY WORKING ORDER AND GOOD CONDITION. REPLACE IF NECESSARY FIELD VERIFY EXISTING ATTIC DOOR SIZE AND LOCATION, TYP ☐**〉**NOT USED R12 PARAPET WALL WITH CAP FLASHING TYPICAL ATTIC DRAFTSTOPPING LOCATION - FULL HEIGHT AND WIDTH - ALIGN WITH SMOKE COMPARTMENT WALLS AS INDICATED, DRAFTSTOPPING TO BE 5/8" GWB OR 1/2" PLYWOOD PER NFPA 101 SECTION 8.6.11

R14 RAILING SEE DETAIL 2,3,4 / A-3.1

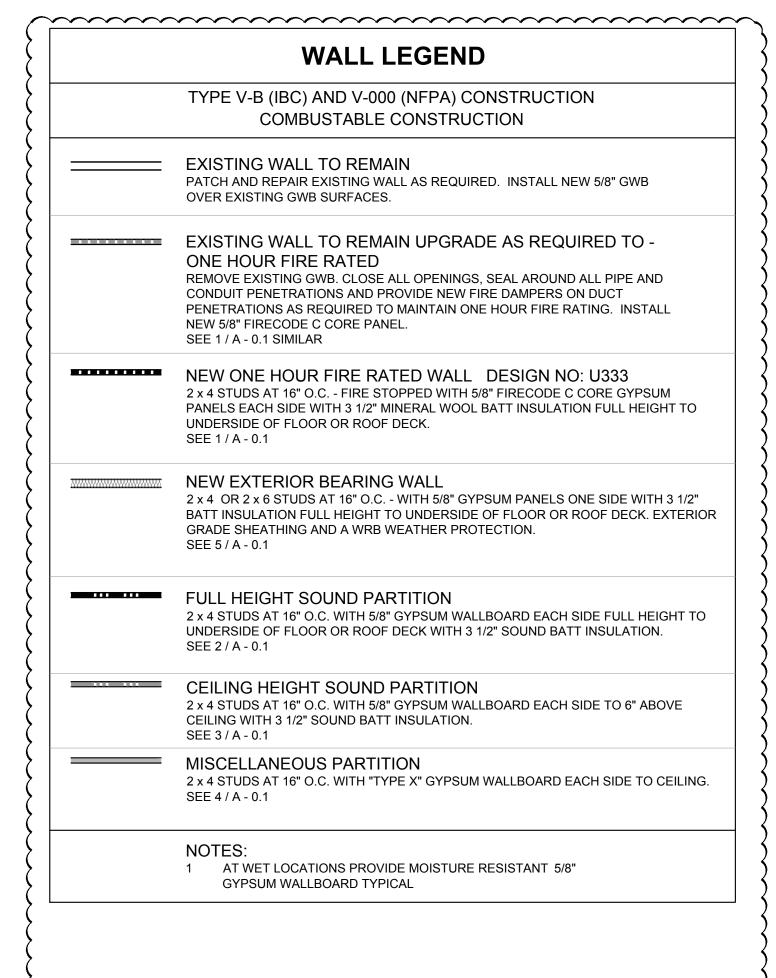

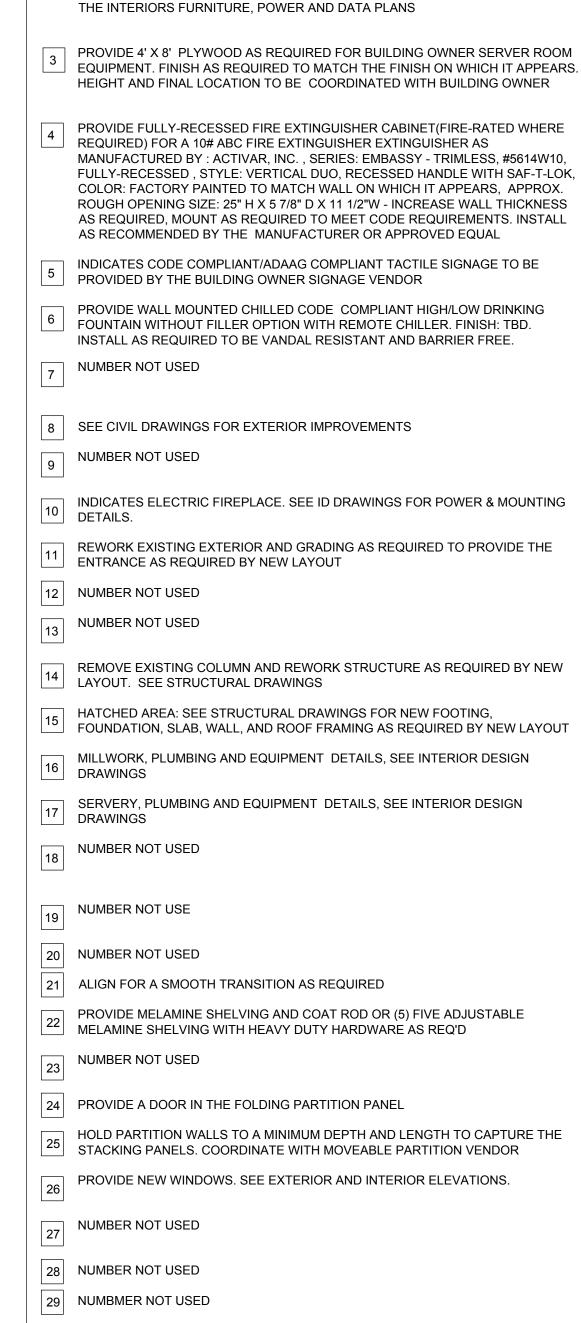

ARCHITECTURAL KEYNOTES

FLUSH IF POSSIBLE

GC TO COORDINATE ALL STRUCTURAL AND FINISHED DIMENSIONS WITH THE MOVEABLE PARTITION MANUFACTURER PRIOR TO STUD INSTALLATION FOR

ACCURATE WALL AND GWB CEILING LOCATION AND SIZE. HOLD GWB SOFFIT

PROVIDE PLYWOOD BLOCKING AS REQUIRED TO MOUNT LCD MONITORS. THE

BEHIND GWB. HEIGHT AND FINAL LOCATION TO BE COORDINATED WITH

BUILDING OWNER REPRESENTATIVE PRIOR TO INSTALLATION. BUILDING

SIZE OF THE BACKER BOARD TO MATCH THE SIZE OF THE LCD SCREEN. INSTALL

OWNER TO COORDINATE TO LCD SCREEN SPECIFICATIONS. COORDINATE WITH

ARCHITECTURAL	GENERAL	NOTES

- 1. GC TO REMOVE EXISTING WALL AND ROOF SHEATHING AS REQUIRED. GC TO VERIFY THE CONDITION OF THE EXISTING FRAMING IS FREE OF; MOLD, DRY ROT, WATER DAMAGE, INSECT DAMAGE, STRUCTURAL DAMAGE, ETC. AND IS SUITABLE FOR INSTALLATION OF NEW WALL AND ROOF SHEATHING PRIOR TO INSTALLATION OF ANY NEW EXTERIOR SHEATHING, TYPICAL
- 2. INSTALL NEW ROOFING SYSTEMS AND ALL OF THEIR COMPONENTS PER THE ROOFING MANUFACTURERS SPECIFICATIONS REQUIREMENTS FOR INSTALLATION AND WARRANTY.
- 3. INSTALL ALL WINDOWS, DOORS AND ALL OF THEIR COMPONENTS PER MANUFACTURERS SPECIFICATIONS REQUIREMENTS FOR INSTALLATION AND WARRANTY, TYPICAL
- 4. G.C. TO VERIFY EXISTING CATWALK LOCATIONS IN ATTIC AND COORDINATE NEW CATWALKS AS REQUIRED WITH EQUIPMENT LOCATIONS, TYPICAL

### ARCHITECTURAL LEGEND

FULLY RECESSED FIRE EXTINGUISHER CABINET FOR ONE 10# ABC FIRE EXTINGUISHER (MP SERIES). PROVIDE FIRE RATED CABINET AS REQUIRED.


FULLY ACCESSIBLE PATIENT ROOM AND BATH

NEW CONSTRUCTION

INFILL /IN PLACE CONCRETE SLAB @ HIGHER ELEVATION TO ALIGN WITH EXISTING CONCRETE FLOOR TO BE SMOOTH AND READY TO RECEIVE NEW FLOOR FINISH, SEE STRUCTURAL DRAWINGS

## Recovery Centers of America **BILLINGSLEY FACILITY BUILDING 3** 11,100 BILLINGSLEY ROAD WALDORF, MARYLAND 220602

Thomas E Hall & Associates, Inc. 240 Conestoga Road Wayne, Pa 19087 (610) 293-9900 www.teh-architects.com Architecture • Interiors • Planning

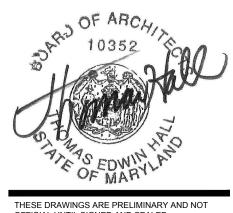

OFFICIAL UNTIL SIGNED AND SEALED.
CONTRACTOR SHALL VERIFY DIMENSIONS AND SITE CONDITIONS AND REPORT ANY DISCREPANCIES TO THE ARCHITECT. THE ARCHITECTS IS NOT RESPONSIBLE FOR ANY UNREPORTED DISCREPANCIES.

Consultant

Project Type

Alteration Remodel

New Addition New Construction

**Drawing Status** 

Design Phase Not For Construction

For Pricing For Permit

Revision For Construction

Revisions No. Date 10 | 06/03/2016 | REVISION #10 /11\ 07/07/2016 | REVISION #11 /12\ 07/27/2016 | REVISION #12 09/16/2016 REVISION #13 01/06/2017 REVISION #14 02/03/2017 ADDENDUM #1

Job No: 6142.00 Drawn By: Checked By: TEH 17 FEB 03 Scale: AS NOTED


Drawing Title: ARCH. PLANS

BLDG. 3


Sheet No:

- ALL TYPE "B" TOILET ROOMS.


- 4. TOILET ACCESSORIES TO BE **POLISHED CHROME.**
- DRAWINGS FOR SPECIFICATIONS.
- PARTITION DOORS AND DOOR SWINGS.

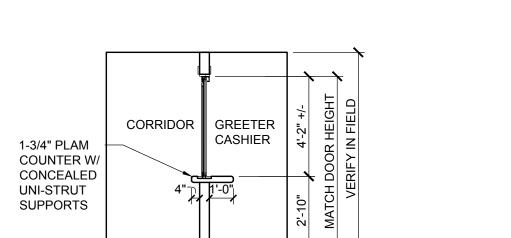


SECTION PASS THROUGH WINDOW BUILDING 3

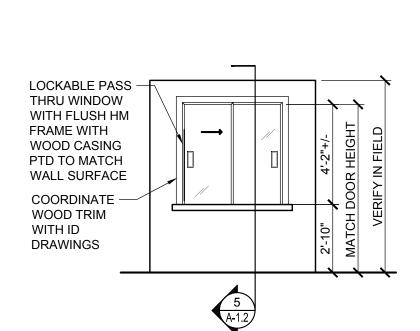

4 PASS THROUGH WINDOW BUILDING 3 A-1.2 / SCALE: 1/4" = 1'-0"

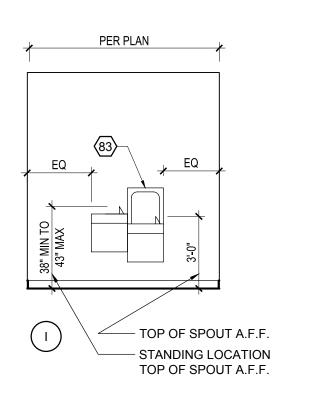


WOMENS TOILET RM ELEVATIONS BUILDING 3 A-1.2 SCALE: 1/4" = 1'-0"

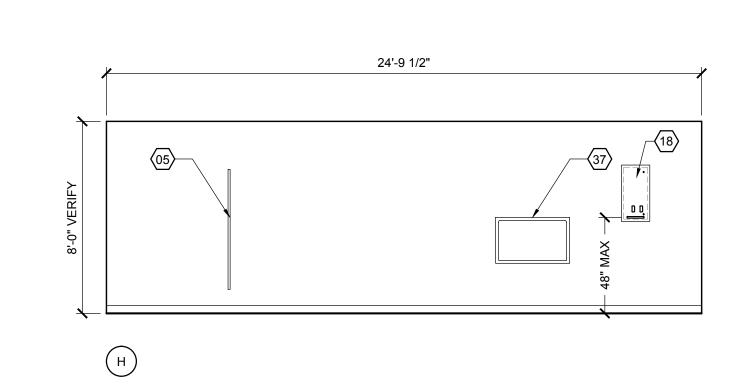


3A \ WOMENS TOILET RM ELEVATIONS BUILDING 3 A-1.2 SCALE: 1/4" = 1'-0"

(21)-

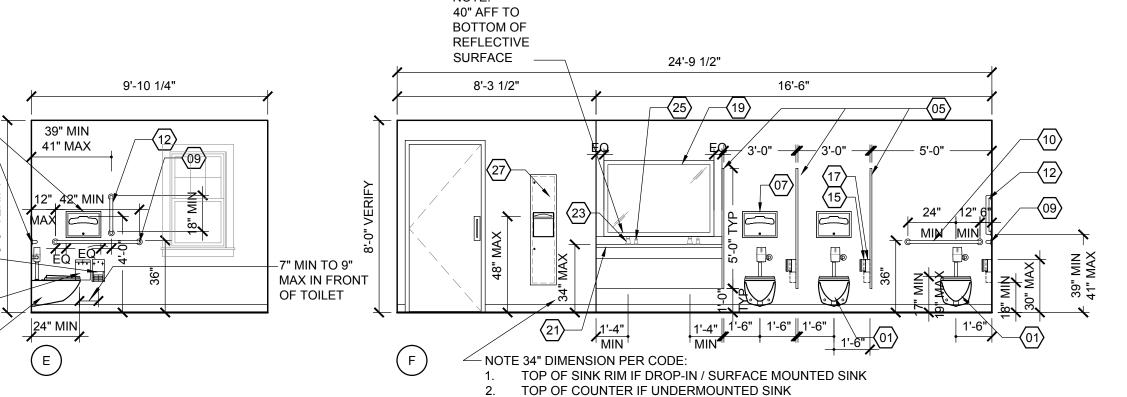


3 \ WOMENS TOILET RM ELEVATIONS BUILDING 3 A-1.2 SCALE: 1/4" = 1'-0"

A-1.2 SCALE: 1/4" = 1'-0"

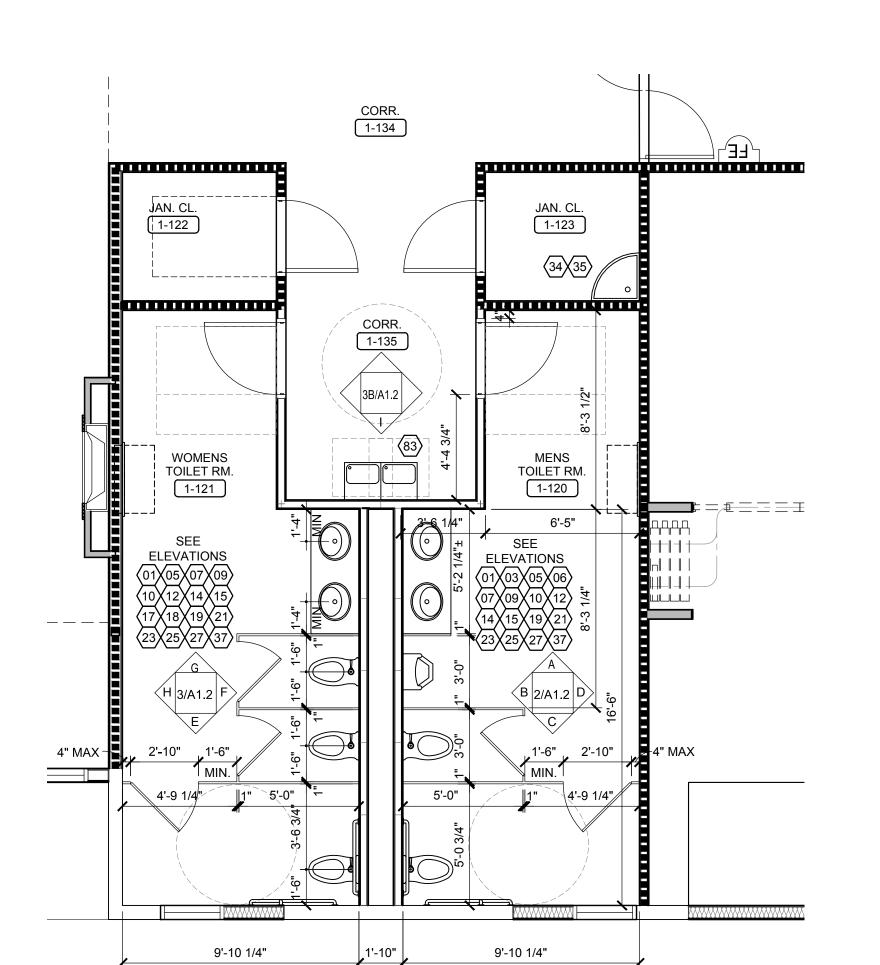

TOILET ROOM PLAN BUILDING 3 A-1.2 SCALE: 1/4" = 1'-0"

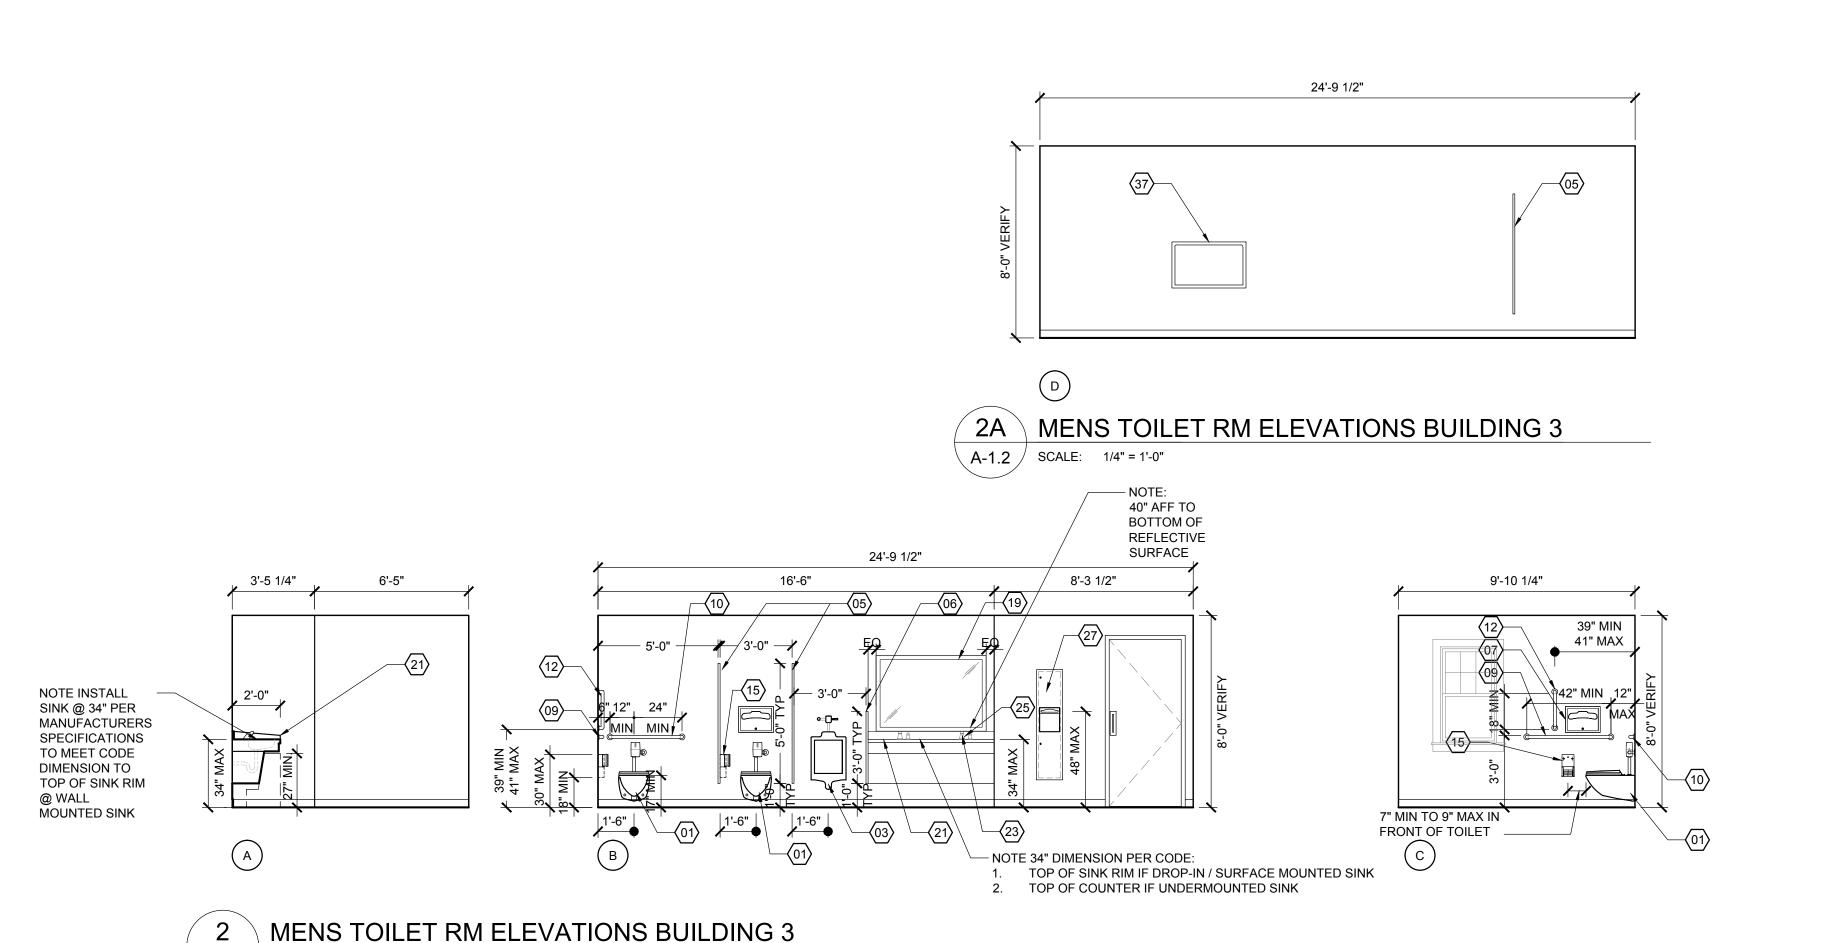

- COORDINATE WITH INTERIOR DESIGN DRAWINGS FOR ALL FIXTURE'S, ACCESSORIES, FINISHES AND SPECIFICATIONS.
- INSTALL BLOCKING AS REQUIRED FOR FUTURE INSTALLATION OF GRAB BARS IN
- 3. WATER CLOSETS AND URINALS SHALL BE VITREOUS CERAMIC CHINA TYPICAL.
- SHOWERS ALL SHOWERS TO RECEIVE TILED WALLS, SEE INTERIOR DESIGN
- 6. ALL ACCESSORIES TO BE COORDINATED FOR CLEARANCES AROUND TOILET
- MOUNT / INSTALL ALL OF THE EQUIPMENT AS REQUIRED TO BE ADAAG / ANSI 117.1
- PROVIDE ALL COMMON AREA TOILETS WITH WALL MOUNTED WATER CLOSET WITH HANDS FREE FLUSH VALVE TOILET PUSH BUTTON HIGH EFFICIENCY FLUSHOMETER
- (06) PAINTED METAL WALL MOUNTED URINAL SCREEN (07) RECESSED TOILET SEAT COVER DISPENSER
  - (09) HORIZONTAL WALL MOUNTED 42" ADAAG / ANSI 117.1 COMPLIANT GRAB BARS (PUBLIC TOILET ROOMS)

(08) HORIZONTAL WALL MOUNTED 48" ADAAG / ANSI 117.1 COMPLIANT GRAB BARS

HORIZONTAL WALL MOUNTED 42" ADAAG / ANSI 117.1 COMPLIANT GRAB BARS

LARGE SCALE PLAN & ELEVATION NOTES

1. THE DIMENSIONS INDICATED ON THESE LARGE SCALE PLANS AND ELEVATIONS ARE

TOILET ROOM EQUIPMENT LIST

WALL MOUNTED ADAAG / ANSI 117.1 COMPLIANT WATER CLOSET WITH HANDS

62 FLOOR MOUNTED WATER CLOSET ADAAG / ANSI 117.1 CODE COMPLIANT WITH

(04) WALL MOUNTED URINAL WITH HANDS FREE FLUSH VALVE

(05) PAINTED METAL FLOOR MOUNTED TOILET PARTITIONS AND DOORS

(03) WALL MOUNTED ADAAG / ANSI 117.1 COMPLIANT URINAL WITH HANDS FREE FLUSH

FREE FLUSH VALVE

LEFT OR RIGHT TRIP LEVER

FROM FINISH FACE OF GWB TO FINISH FACE OF GWB. UNLESS NOTED OTHERWISE.

- (PRIVATE TOILET ROOMS) (10) HORIZONTAL WALL MOUNTED 36" ADAAG / ANSI 117.1 COMPLIANT GRAB BARS
- (PUBLIC TOILET ROOMS) (0A) HORIZONTAL WALL MOUNTED 36" ADAAG / ANSI 117.1 COMPLIANT GRAB BARS
- (PRIVATE TOILET ROOMS)
- (11) HORIZONTAL WALL MOUNTED 18 21" ADAAG / ANSI 117.1 COMPLIANT GRAB BARS (PRIVATE ROLL IN SHOWER)
- VERTICAL WALL MOUNTED 18" ANSI 117.1 COMPLIANT GRAB BARS (PUBLIC TOILET AND PUBLIC SHOWER)
- VERTICAL WALL MOUNTED 18" ANSI 117.1 COMPLIANT GRAB BARS (PRIVATE TOILET AND SHOWER)
- (1) ONE CONTINUOUS HORIZONTAL WALL MOUNTED GRAB BAR LH / RH SEE PLAN AT TRANSFER SHOWER AS REQUIRED ADAAG / ANSI 117.1 COMPLIANT.
- (14) COAT HOOK ON BACK OF ALL TOILET PARTITION DOORS (ONE PER STALL). SEE INTERIOR DRAWINGS FOR DETAILS.
- PATIENT TOILET ROOMS/SINGLE PUBLIC TOILET ROOM COAT HOOKS. SEE INTERIOR DRAWINGS FOR MOUNTING LOCATIONS.
- SURFACE MOUNTED ADAAG / ANSI 117.1 COMPLIANT DOUBLE TOILET PAPER DISPENSER FOR PUBLIC GANG TOILETS
- RECESSED MOUNTED ADAAG / ANSI 117.1 COMPLIANT DOUBLE TOILET PAPER DISPENSER FOR PUBLIC TOILET ROOMS
- SURFACE MOUNTED ADAAG / ANSI 117.1 COMPLIANT DOUBLE TOILET PAPER DISPENSER FOR PRIVATE TOILET ROOMS
- (16) NOT USED (17) SURFACE MOUNTED SANITARY NAPKIN DISPOSAL FOR WOMEN'S STALLS AND
- WOMEN'S AND UNISEX TOILET ROOMS ONLY (18) RECESSED NAPKIN / TAMPON VENDOR FOR WOMEN'S GANG TOILET ROOMS ONLY
- WALL MOUNTED FIXED POSITION 2" FRAMED MIRROR CODE COMPLIANT MIRROR THEFT PROOF INSTALLATION - SEE INTERIOR DRAWINGS FOR DETAILS
- (20) GRANITE / MARBLE / QUARTZ SURFACE / SOLID SURFACE COUNTER WITH APRON TO USE WITH AN UNDERMOUNT BOWL, INCLUDE GRID DRAIN AND P-TRAP. PROVIDE REMOVABLE CABINET FOR ACCESSIBILITY AT ALL TYPICAL BATHROOMS.
- GRANITE / MARBLE / QUARTZ SURFACE / SOLID SURFACE COUNTER WITH SEMI COUNTERTOP SINK WITH FAUCET, INCLUDE GRID DRAIN AND P-TRAP
- WALL MOUNTED LAVATORY WITH FAUCET, KNEE CONTACT GUARD, INCLUDE GRID DRAIN AND P-TRAP
- (23) HANDS FREE CONTROL LAVATORY FAUCET MODEL
- 24 SINGLE LEVER SINK FAUCET CODE COMPLIANT
- (25) HANDS FREE COUNTER TOP SOAP DISPENSER
- (26) RECESSED WALL/DECK MOUNTED SOAP DISPENSER WITH SOAP VESSEL RECESSED PAPER TOWEL DISPENSER AND DISPOSAL - ADAAG / ANSI 117.1 CODE COMPLIANT
- (28) RECESSED PAPER TOWEL DISPENSER AND DISPOSAL
- WALL MOUNTED TOWEL BAR CODE COMPLIANT INSTALL ONE PER PATIENT BATHROOM TYPICAL
- SHOWER RECEPTOR BARRIER FREE MOULDED FIBERGLASS, 2" PNC NON CAULK DRAIN, LH / RH TO BE DETERMINED, G.C. TO VERIFY RECEPTOR COMPLIES WITH CODE FOR "FA", ROLL-IN SHOWERS, TRANSFER SHOWERS AND TYPE "B" UNITS.
- ADULT FOLDING SHOWER SEAT ADAAG / ANSI 117.1 CODE COMPLIANT BARRIER FREE SEE PLAN FOR LH / RH
- SHOWER HAND SHOWER SYSTEM WITH SLIDE BAR PROVIDE ALL COMPONENTS AS REQUIRED. MOUNT AS REQUIRED TO BE ADAAG / ANSI 117.1 CODE COMPLIANT
- RECESSED SOAP/SHAMPOO/CONDITIONER DISPENSERS ADAAG / ANSI 117.1 CODE COMPLIANT
- (34) SERVICE SINK
- (35) SERVICE SINK FAUCET & SERVICE SINK FITTINGS
- PROVIDE BLOCKING FOR FUTURE (2) TWO SWING UP GRAB BARS WALL MOUNTED MINIMUM 29" LONG ADAAG / ANSI 117.1 COMPLIANT GRAB BARS PROVIDE ONE SWING UP GRAB BAR WITH INTEGRAL TOILET PAPER HOLDER
- HORIZONTAL RECESSED MOUNTED BABY CHANGING STATION ADAAG / ANSI 117.
- WALL MOUNTED FIXED POSITION 2" FRAMED FULL WIDTH MIRROR CODE COMPLIANT MIRROR THEFT PROOF INSTALLATION SEE INTERIOR DRAWINGS
- (39) TYPICAL SHOWER HEAD OPTION RAIN SHOWER
- 40 TYPICAL DIVERTER

## ANCILLARY SINKS & FAUCETS EQMT. LIST

- SINGLE LEVER FAUCET AT LOUNGE / CAFE ADAAG / ANSI 117.1 CODE COMPLIANT
- 51) SINGLE LEVER FAUCET OTHER COMMON AREA ROOMS (52) NOT USED
- UNDERMOUNT SINGLE BOWL SINK ADAAG / ANSI 117.1 CODE COMPLIANT AT GROUP ROOM/LOUNGE/COFFEE BAR
- UNDERMOUNT SINGLE BOWL STAINLESS STEEL BAR SINK ADAAG / ANSI 117.1

### MISCELLANEOUS EQUIPMENT LIST


(80) FRONT ELECTRIC LOADING WASHER

- (81) ELECTRIC DRYER
- 82 STACKABLE ELECTRIC FRONT LOADING WASHER AND DRYER
- (83) WALL MOUNTED TOUCHLESS ADA COMPLIANT BOTTLE FILLER STATION WITH HI/LO - FILTERED COOLER, VANDAL RESISTANT & BARRIER FREE


TOIL. RM. PLANS & ELEV'S BLDG. 3 Sheet No: A-1.2

Copyright © by Thomas E. Hall & Associates, Inc., Wayne, PA 19087, Phone number (610) 293-9900. All rights reserved.

Recovery Centers of America

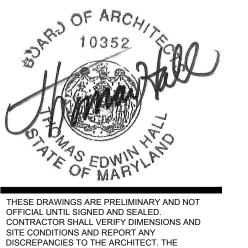

ARCHITECTS IS NOT RESPONSIBLE FOR ANY UNREPORTED DISCREPANCIES. Consultant

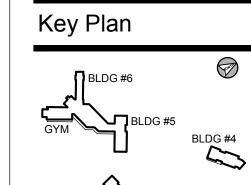

Project Type Alteration Remodel

New Addition New Construction

**Drawing Status** 

Design Phase Not For Construction

For Pricing

For Permit Revision

For Construction

Revisions

No. Date

06/03/2016 | REVISION #10 07/07/2016 REVISION #11 12 07/27/2016 REVISION #12

09/16/2016 REVISION #13 01/06/2017 REVISION #14

02/03/2017 ADDENDUM #1 Job No: 6142.00 Drawn By:

Date: 17 FEB 03 Scale: AS NOTED Drawing Title:

Checked By: TEH

**BILLINGSLEY BUILDING 3** 

- INSULATION OPTIONAL IN CONCEALED SPACE DIRECTLY OVER GYPSUM CEILING

1-HR RATING

- USG DGL DRYWALL SUSPENSION SYSTEM
- SHEETROCK BRAND FIRECODE "C" OR "X" CORE GYPSUM PANELS

2 DETAIL - UL DESIGN P522

**A-1.3** / SCALE: 1-1/2" = 1'-0"

manne an antime and a sure a sure and a sure a sure and a sure a sure and a sure a sure and a sure a sure and a sure a sure and a sure a sure and a sure and a sure and a sure a sur




Project

**BILLINGSLEY FACILITY BUILDING 3** 11,100 BILLINGSLEY ROAD WALDORF.




MARYLAND 220602

Thomas E Hall & Associates, Inc. 240 Conestoga Road Wayne, Pa 19087 (610) 293-9900 www.teh-architects.com Architecture • Interiors • Planning

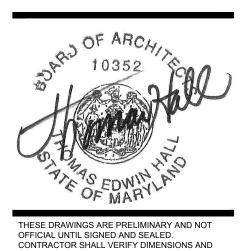

SITE CONDITIONS AND REPORT ANY
DISCREPANCIES TO THE ARCHITECT. THE ARCHITECTS IS NOT RESPONSIBLE FOR ANY UNREPORTED DISCREPANCIES.

Consultant

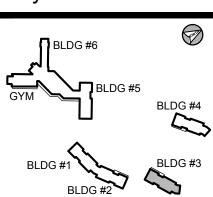

Project Type

Alteration

REFLECTED CEILING PLAN LEGEND

SEE ELECTRICAL LIGHTING PLAN FOR FIXTURE TYPE

CEILING. ALL DIMENSIONS TO FIELD VERIFIED, TYPICAL.

REFLECTED CEILING PLAN GENERAL NOTES

1. SEE INTERIOR DESIGN DRAWINGS FOR CEILING FINISHES, SOFFITS, DETAILS, SECTIONS,

2. CEILING PLAN SHALL BE USED FOR FIRE RATINGS AND CEILINGS HEIGHTS ONLY. REFER

5. ALL BEARING WALLS, CORRIDOR CEILINGS AND BETWEEN FLOORS SHALL BE ONE HOUR

UL DETAILS SHOWN ARE FOR REFERENCE ONLY PLEASE CONSULT THE UL DESIGN

6. ALL FIXTURES IN ONE HOUR FIRE RATED CEILING LOCATIONS TO BE ONE HOUR FIRE

7. ALL LIGHTING, SPEAKERS, CAMERAS, DUCTWORK AND SPRINKLER HEADS SHOWN ARE

FOR REFERENCE ONLY. SEE APPROPRIATE DISCIPLINE DRAWINGS FOR MORE

RATED FIXTURES, TYPICAL. COORDINATE LAMPING AS REQUIRED, TYPICAL

DIRECTORY FOR COMPLETE LISTING OF MANUFACTURERS AND PROPER ASSEMBLY.

TO THE APPROPRIATE DISCIPLINE DRAWINGS FOR MORE INFORMATION.

PROVIDE GWB FIRE RATED CEILING ASSEMBLY WITH NON-RATED

INTERIOR DESIGN DRAWINGS RECESSED LIGHT FIXTURE

ACCOUSTICAL DROP CEILING WITH RECESSED LIGHT FIXTURES. SEE

INTERIOR DESIGN DRAWINGS. VERIFY FINISH CEILING HEIGHT WITH

SYMBOL INDICATES THE APPROXIMATE DIMENSION FROM FLOOR TO FINISH

INDICATES EXTERIOR LIGHT FIXTURE

INDICATES / CEILING IS 1 HOUR RATED

HOUSING, TYPICAL.

3. FINAL FIXTURE SELECTION BY OWNER / INTERIOR DESIGNER.

INFORMATION.

4. FINAL COLOR / FINISH SELECTION BY OWNER / INTERIOR DESIGNER.

FIRE RATED

TYPICAL CEILING / ROOF:

TYPICAL INTERIOR WALL:

UL DESIGN NO. U 3 3 3 4.

Remodel

New Addition New Construction

**Drawing Status** 

Design Phase Not For Construction

For Pricing

For Permit

Revision For Construction


Revisions


No. Date

06/03/2016 REVISION #10 07/07/2016 REVISION #11 07/27/2016 REVISION #12 09/16/2016 REVISION #13 01/06/2017 REVISION #14

02/03/2017 ADDENDUM #1 Job No: 6142.00


Drawn By: Checked By: TEH Date: 17 FEB 03 AS NOTED Scale: Drawing Title:

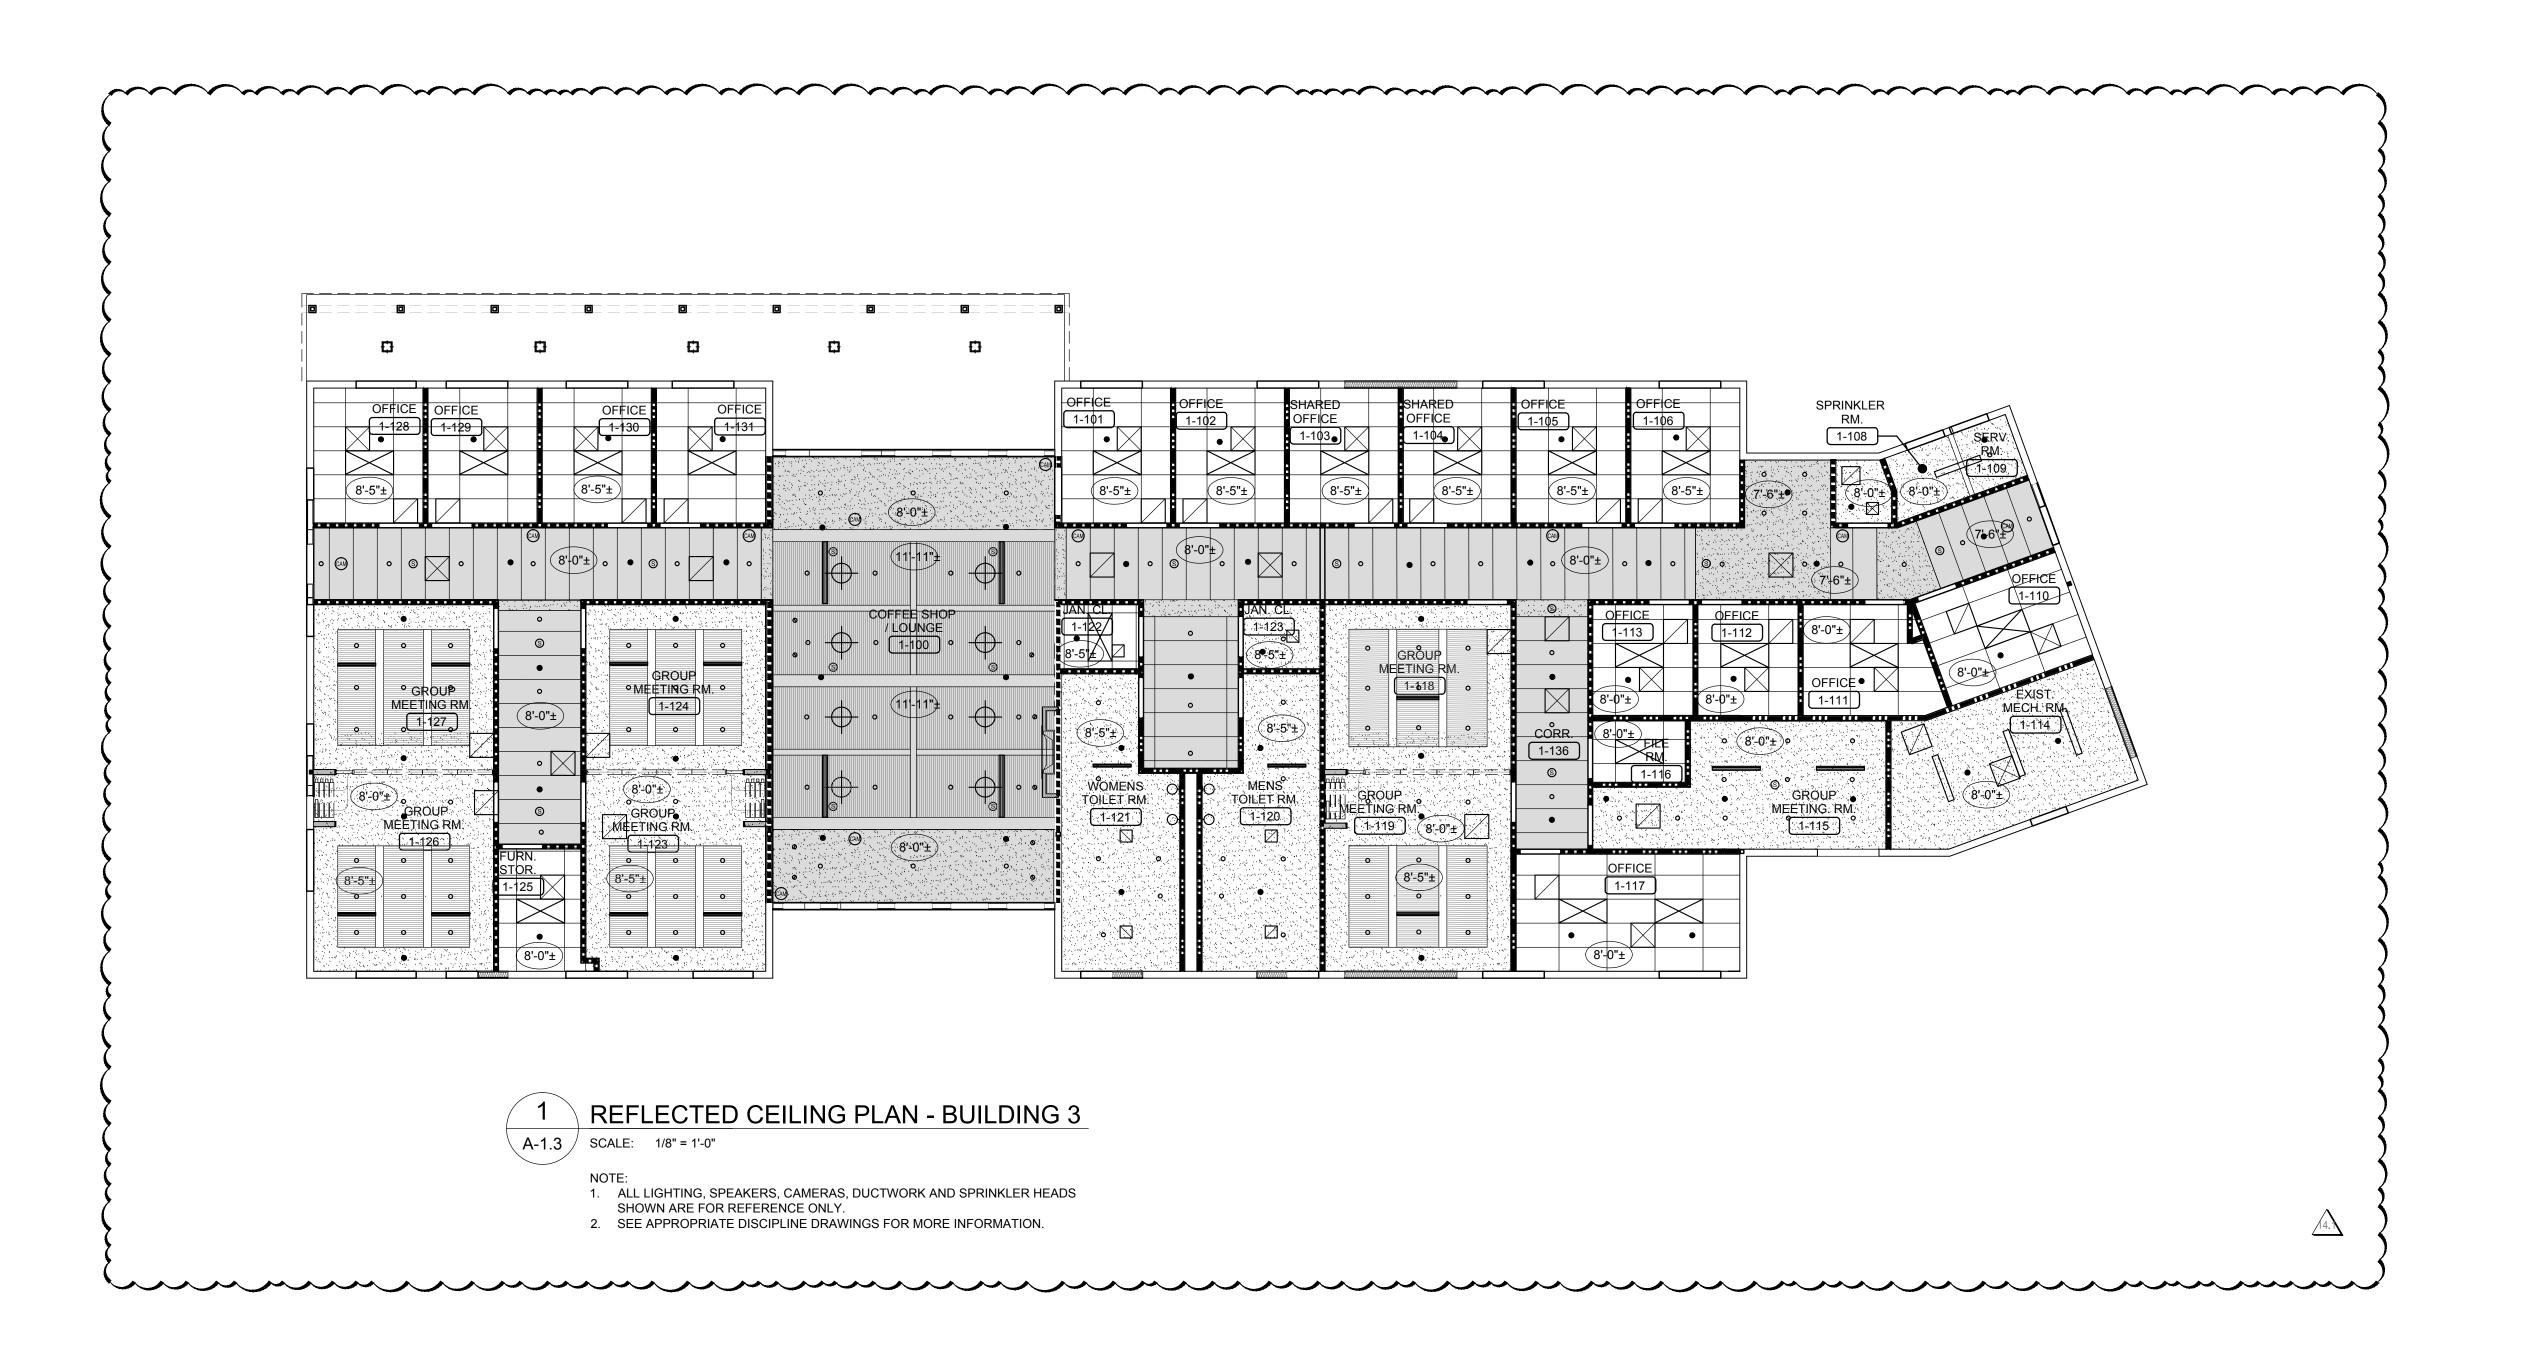

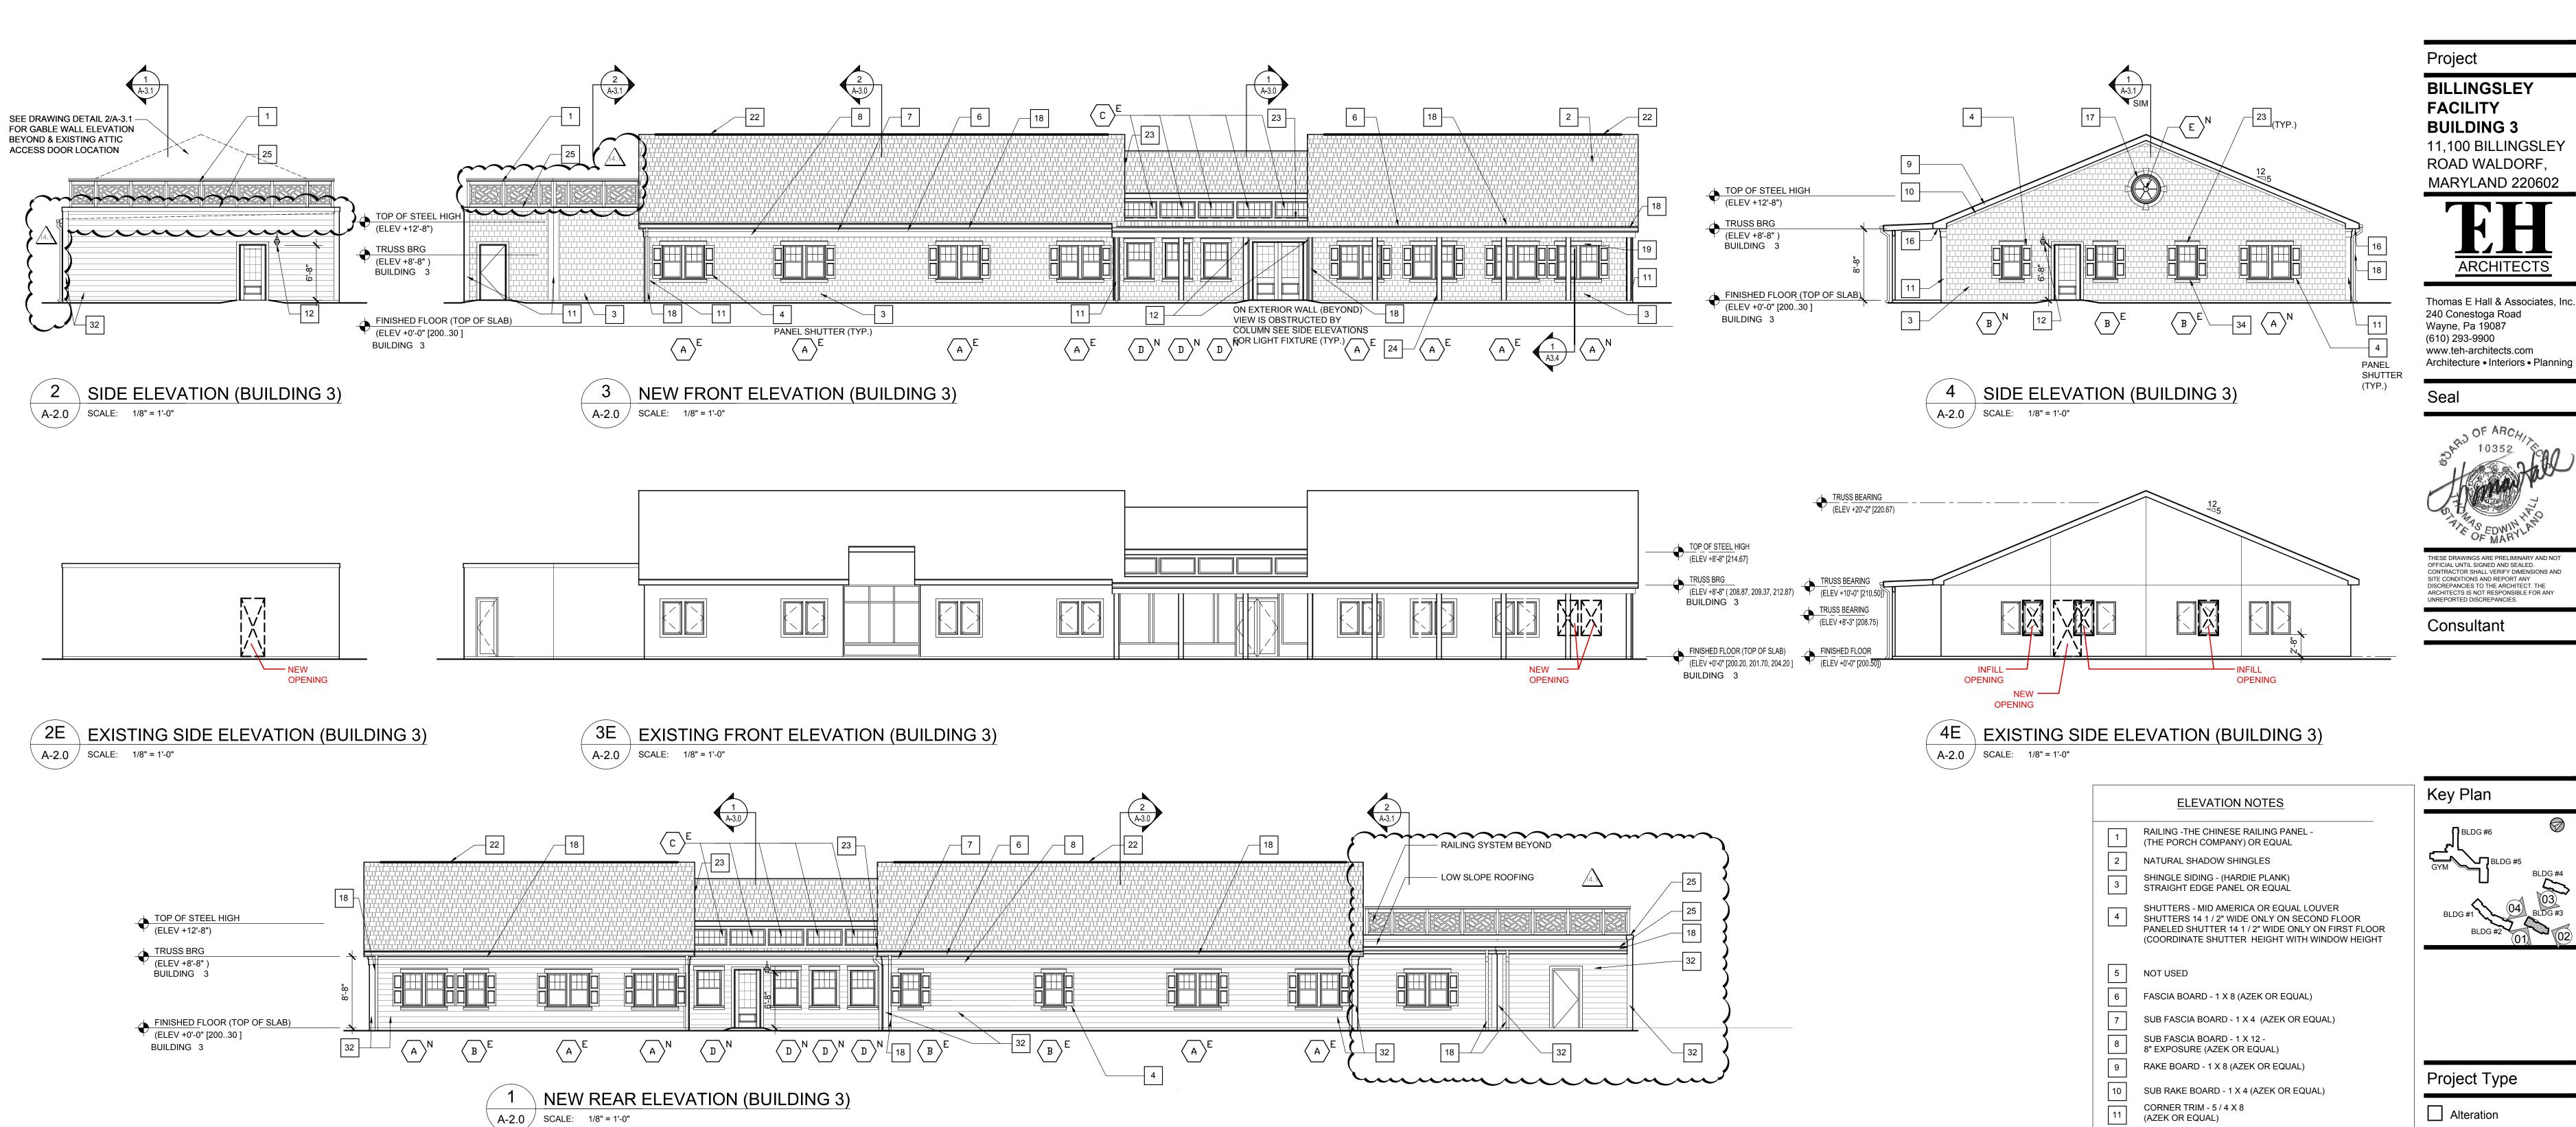

NEW ——V

OPENING

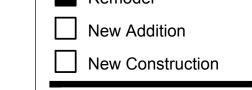

Not For Construction

For Permit Revision

NEW CONTINUOUS RIDGE VENT (USE SAME LOCATIONS OR AS NOTED OTHERWISE) CONTINUOUS METAL FLASHING

(OVER WINDOWS AND AS SHOWN ON ELEVATIONS) EXISTING WOOD POST TO BE

24 PAINTED PRE-FINISHED METAL COPING REPLACE WITH NEW AZEK BOARD

LIGHT FIXTURE - (VAXCEL LIGHTING)OR EQUAL) OW21861BN NAUTICAL 7"

NEW GUTTER AND DOWNSPOUTS (USE SAME LOCATIONS OR AS NOTED OTHERWISE)

4" WINDOW CASING 5 / 4 X 4 TRIM BOARD (AZEK OR

EQUAL) SEE DETAILS 3/ A-6.0 AND 4 / A-6.0

CONTINUOUS 2" VENT W/ AZEK

TRIM ON BOTH SIDES

13

14

15

20

21

NOT USED

NOT USED

REPLACE SUBSTRATE AS REQUIRED 27 AIR VENT (CLOSED)

28 NOT USED

AZEK BAND MOULD AZM-217 STUDS. AZEK TRIM

BOX OUT COLUMN WITH 2X4 NOT USED

8" HORIZONTAL SIDING W/ 8" CORNER TRIM (CERTAIN TEED CAROLINA VINYL SIDING OR EQUAL) 5" WINDOW TRIM (AZEK OR EQUAL)

33 34 WINDOW APRON (AZEK OR EQUAL)

AS REQUIRED (TYP.)

35 NOT USED 36 RAILING CAP (AZEK OR EQUAL)

3/4" AZEK SHEET STOCK CLADDING REMOVE ANY MECHANICAL ROOF PENETRATIONS THAT ARE NOT APPLICABLE PATCH AND REPAIR

WINDOW KEY LEGEND

EXISTING WINDOW OPENING, WITH NEW WINDOWS. G.C. TO FIELD VERIFY EXISTING R.O. PRIOR TO ORDERING NEW WINDOWS. NEW WINDOW OPENING, WITH NEW WINDOWS. G.C. TO MATCH

NEW WINDOW R.O. WITH EXISTING, FIELD VERIFY EXISTING R.O. PRIOR TO ORDERING NEW WINDOWS.

E = EXISTING ROUGH OPENING N = NEW ROUGH OPENING

## ARCHITECTURAL GENERAL NOTES

1. GC TO REMOVE EXISTING WALL AND ROOF SHEATHING AS REQUIRED. GC TO VERIFY THE CONDITION OF THE EXISTING FRAMING IS FREE OF; MOLD, DRY ROT, WATER DAMAGE, INSECT DAMAGE, STRUCTURAL DAMAGE, ETC. AND IS SUITABLE FOR INSTALLATION OF NEW WALL AND ROOF SHEATHING PRIOR TO INSTALLATION OF ANY NEW EXTERIOR SHEATHING, TYPICAL

INSTALL NEW ROOFING SYSTEMS AND ALL OF THEIR COMPONENTS PER THE ROOFING MANUFACTURERS SPECIFICATIONS REQUIREMENTS FOR INSTALLATION AND WARRANTY.

3. INSTALL ALL WINDOWS, DOORS AND ALL OF THEIR COMPONENTS PER MANUFACTURERS SPECIFICATIONS REQUIREMENTS FOR INSTALLATION AND WARRANTY, TYPICAL

4. G.C. TO VERIFY EXISTING CATWALK LOCATIONS IN ATTIC AND COORDINATE NEW CATWALKS AS REQUIRED WITH EQUIPMENT LOCATIONS, TYPICAL

Copyright © by Thomas E. Hall & Associates, Inc., Wayne, PA 19087, Phone number (610) 293-9900. All rights reserved.

TRUSS BEARING (ELEV +20'-2" [220.67]

TRUSS BEARING
(ELEV +8'-3" [208.75]

FINISHED FLOOR
(ELEV +0'-0" [202.00]

NEW ——V

OPENING

INFILL

OPENING

A-2.0 SCALE: 1/8" = 1'-0"

V\_\_\_\_NEW

OPENING

EXISTING REAR ELEVATION (BUILDING 3)

— INFILL ———

OPENING

BILLINGSLEY BUILDING 3



## Project Type Alteration

Remodel

## **Drawing Status**

Design Phase

For Pricing

For Construction

## Revisions

No. Date Description 06/03/2016 REVISION #10 07/07/2016 REVISION #11 07/27/2016 REVISION #12 09/16/2016 REVISION #13 01/06/2017 REVISION #14 02/03/2017 ADDENDUM #1


Job No: 6142.00 Drawn By: 17 FEB 03

Checked By: TEH AS NOTED Scale: Drawing Title:

ARCH. ELEVATIONS BLDG. 3

Sheet No:

A-2.0

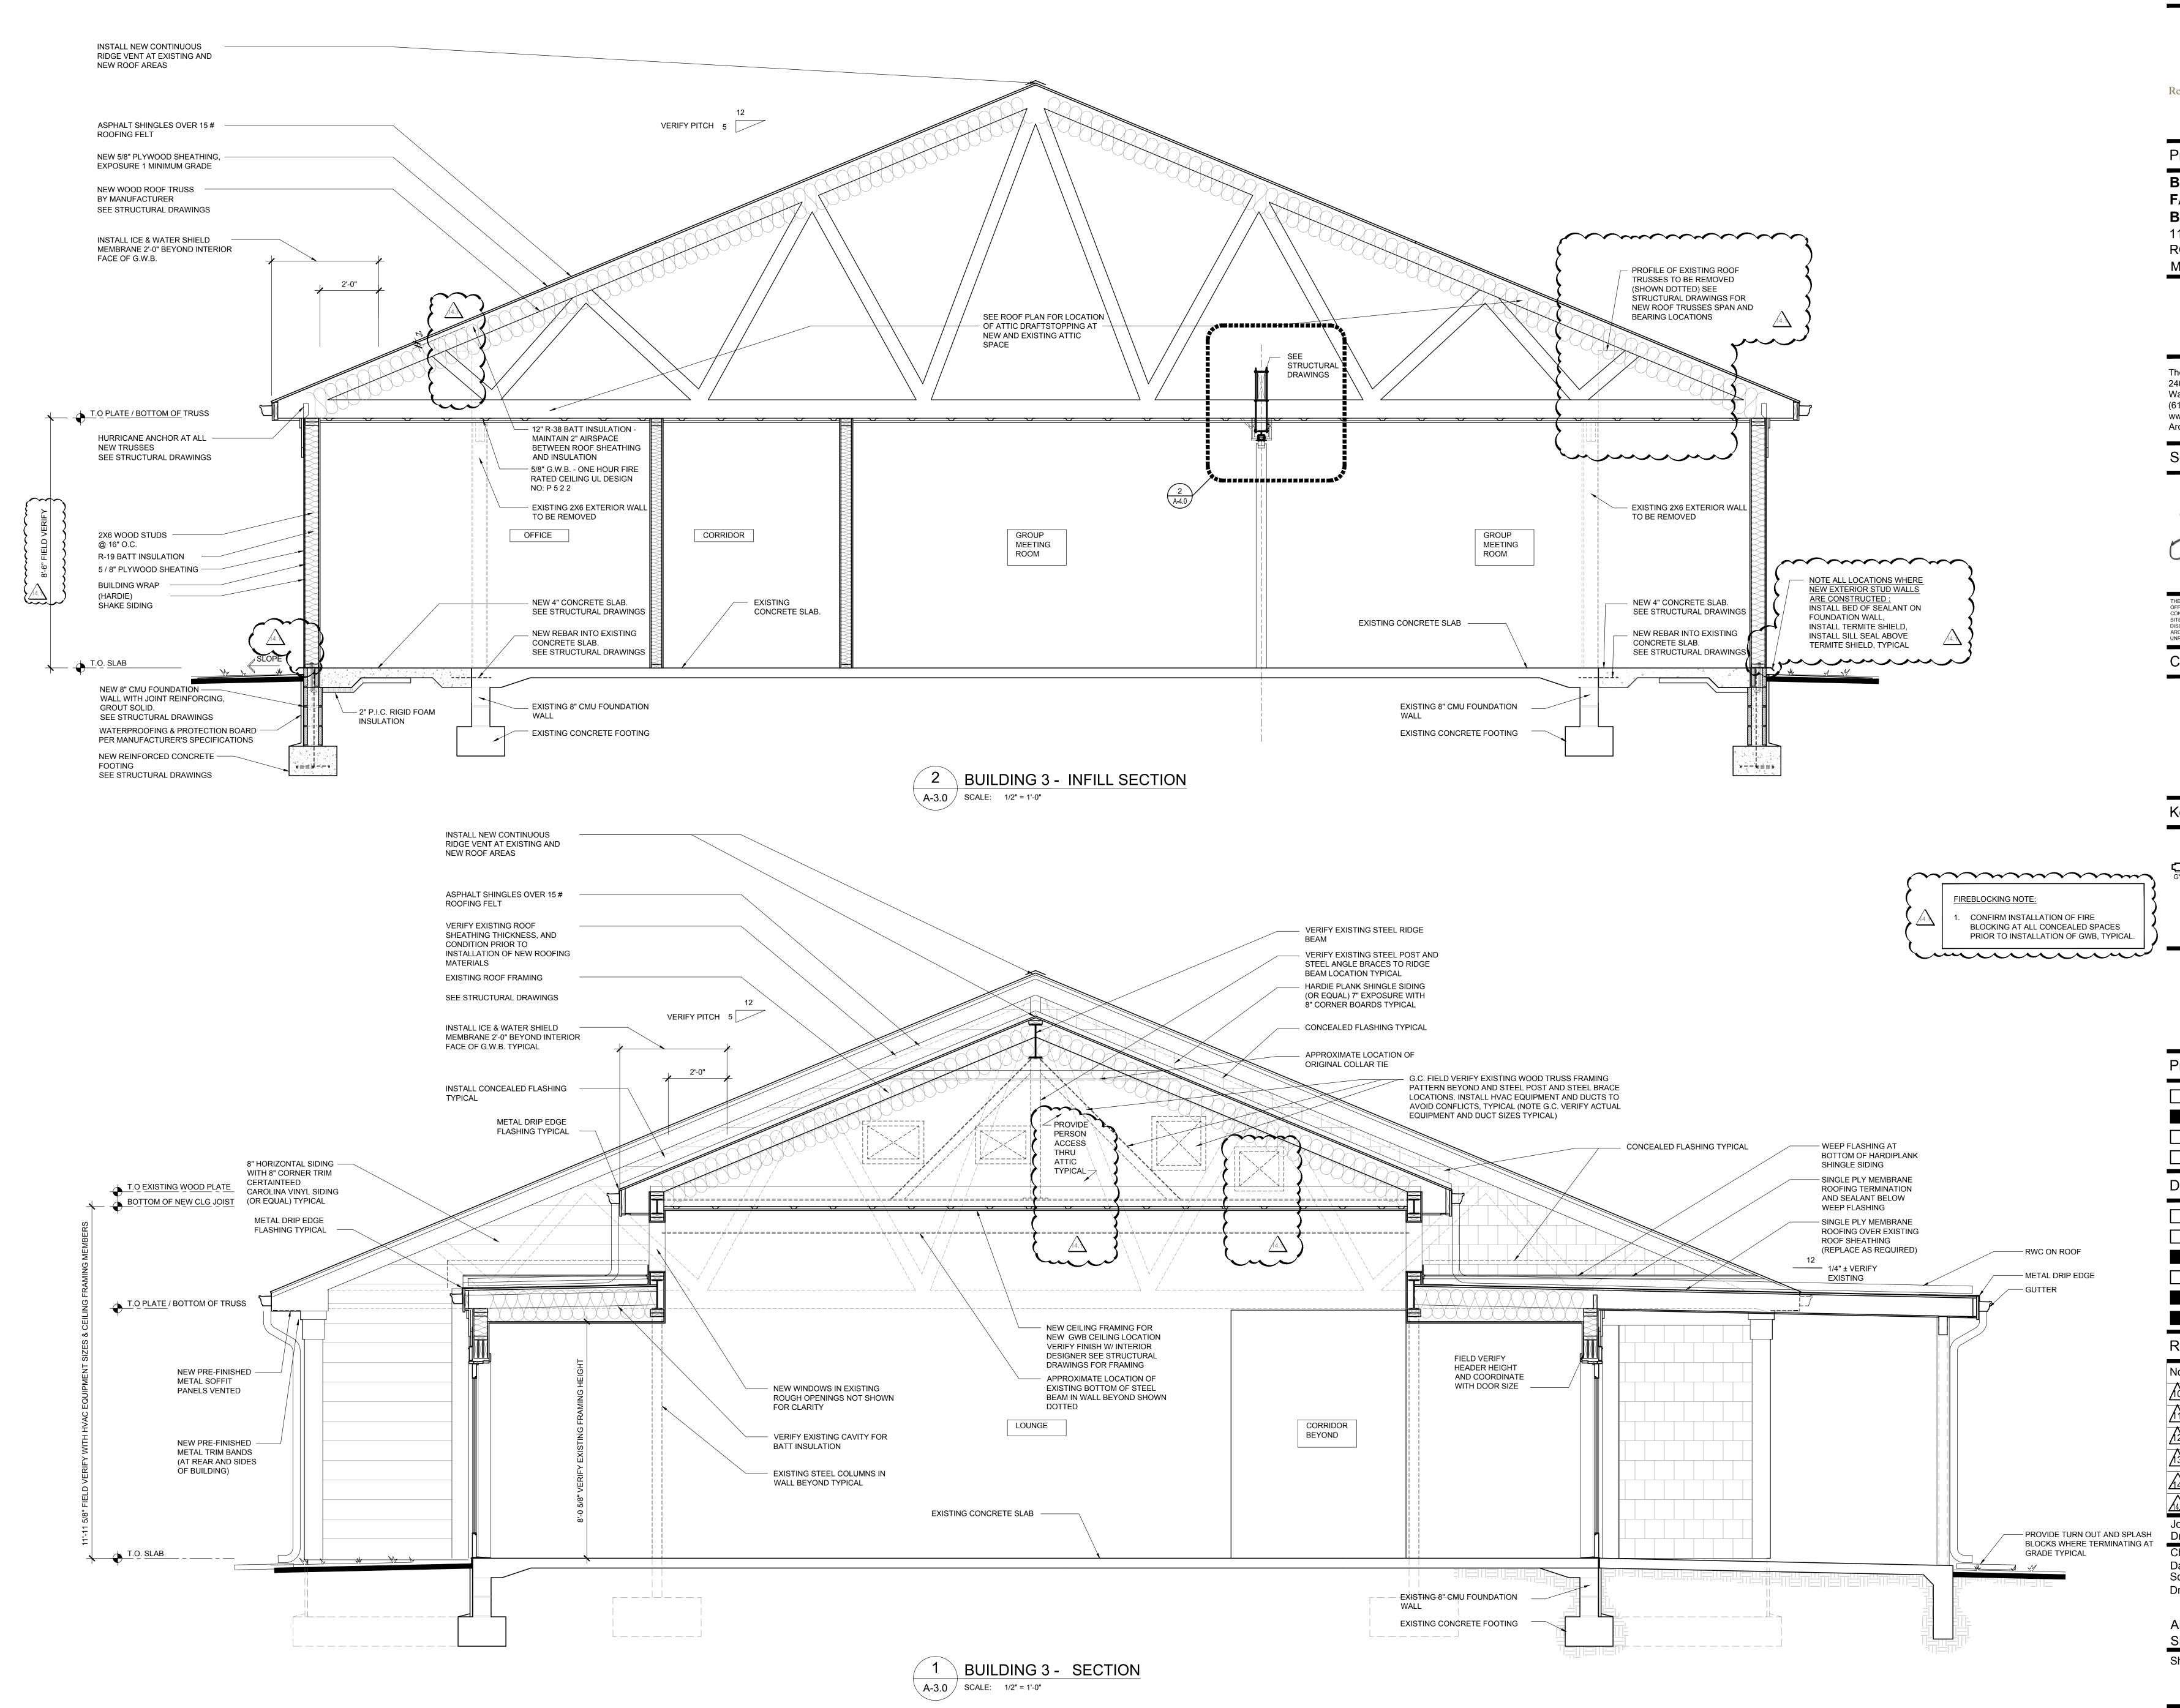

Recovery Centers of America

**BILLINGSLEY FACILITY BUILDING 3** 

11,100 BILLINGSLEY ROAD WALDORF, MARYLAND 220602

Thomas E Hall & Associates, Inc. 240 Conestoga Road Wayne, Pa 19087 (610) 293-9900 www.teh-architects.com Architecture • Interiors • Planning



THESE DRAWINGS ARE PRELIMINARY AND NOT OFFICIAL UNTIL SIGNED AND SEALED.
CONTRACTOR SHALL VERIFY DIMENSIONS AND SITE CONDITIONS AND REPORT ANY
DISCREPANCIES TO THE ARCHITECT. THE ARCHITECTS IS NOT RESPONSIBLE FOR ANY UNREPORTED DISCREPANCIES.

Consultant

Project Type

Alteration Remodel

New Addition New Construction

**Drawing Status** 

Design Phase Not For Construction

For Pricing For Permit

Revision For Construction

Revisions

No. Date

06/03/2016 | REVISION #10 07/07/2016 REVISION #11 72 07/27/2016 REVISION #12 09/16/2016 REVISION #13 01/06/2017 REVISION #14


02/03/2017 ADDENDUM #1 Job No: 6142.00

Drawn By: FJF Checked By: TEH Scale: AS NOTED

Drawing Title: ARCHITECTURAL

SECTIONS Sheet No:

A-3.0

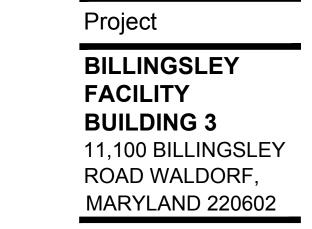


Thomas E Hall & Associates, Inc. 240 Conestoga Road Wayne, Pa 19087

Architecture • Interiors • Planning

(610) 293-9900

www.teh-architects.com

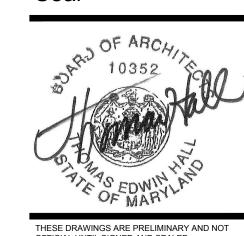


OFFICIAL UNTIL SIGNED AND SEALED.
CONTRACTOR SHALL VERIFY DIMENSIONS AND SITE CONDITIONS AND REPORT ANY
DISCREPANCIES TO THE ARCHITECT. THE ARCHITECTS IS NOT RESPONSIBLE FOR ANY UNREPORTED DISCREPANCIES.

Consultant

PRIOR TO INSTALLATION OF GWB, TYPICAL. 

FIREBLOCKING NOTE:

CONFIRM INSTALLATION OF FIRE BLOCKING AT ALL CONCEALED SPACES

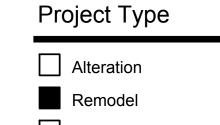

New Addition New Construction

**Drawing Status** 

Design Phase Not For Construction

For Pricing For Permit

Revision For Construction

## Revisions

No.	Date	Description
$\sqrt{\mathbf{Q}}$	06/03/2016	REVISION #10
<u>M</u>	07/07/2016	REVISION #11
12	07/27/2016	REVISION #12
13	09/16/2016	REVISION #13
14	01/06/2017	REVISION #14
14.1	02/03/2017	ADDENDUM #1


Job No: 6142.00 Drawn By: FJF Checked By: TEH 17 FEB 03 AS NOTED Scale:


Drawing Title:


BILLINGSLEY BUILDING 3

ARCHITECTURAL SECTIONS Sheet No:



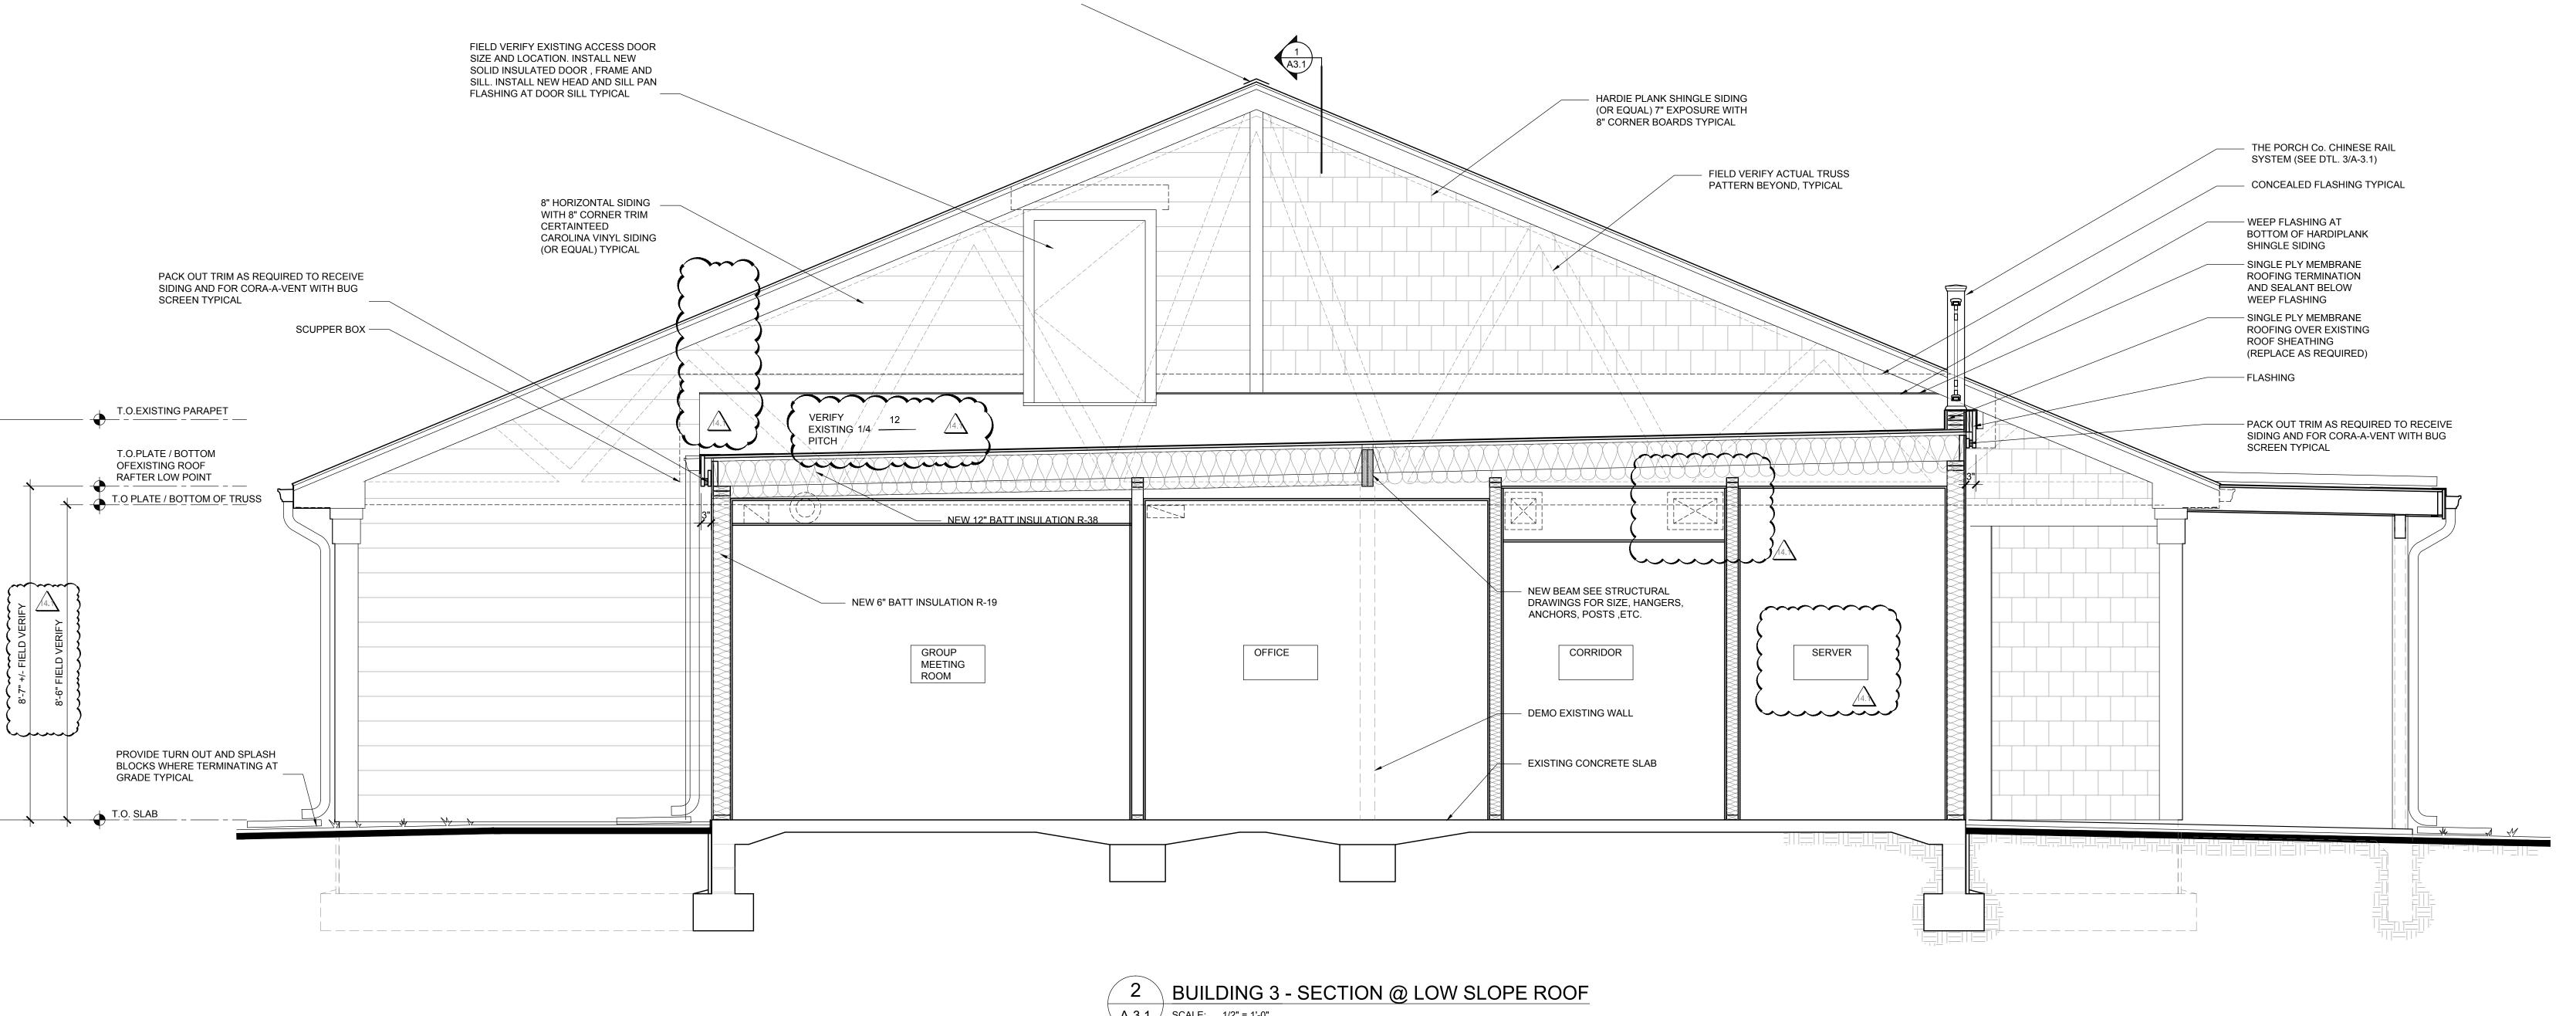

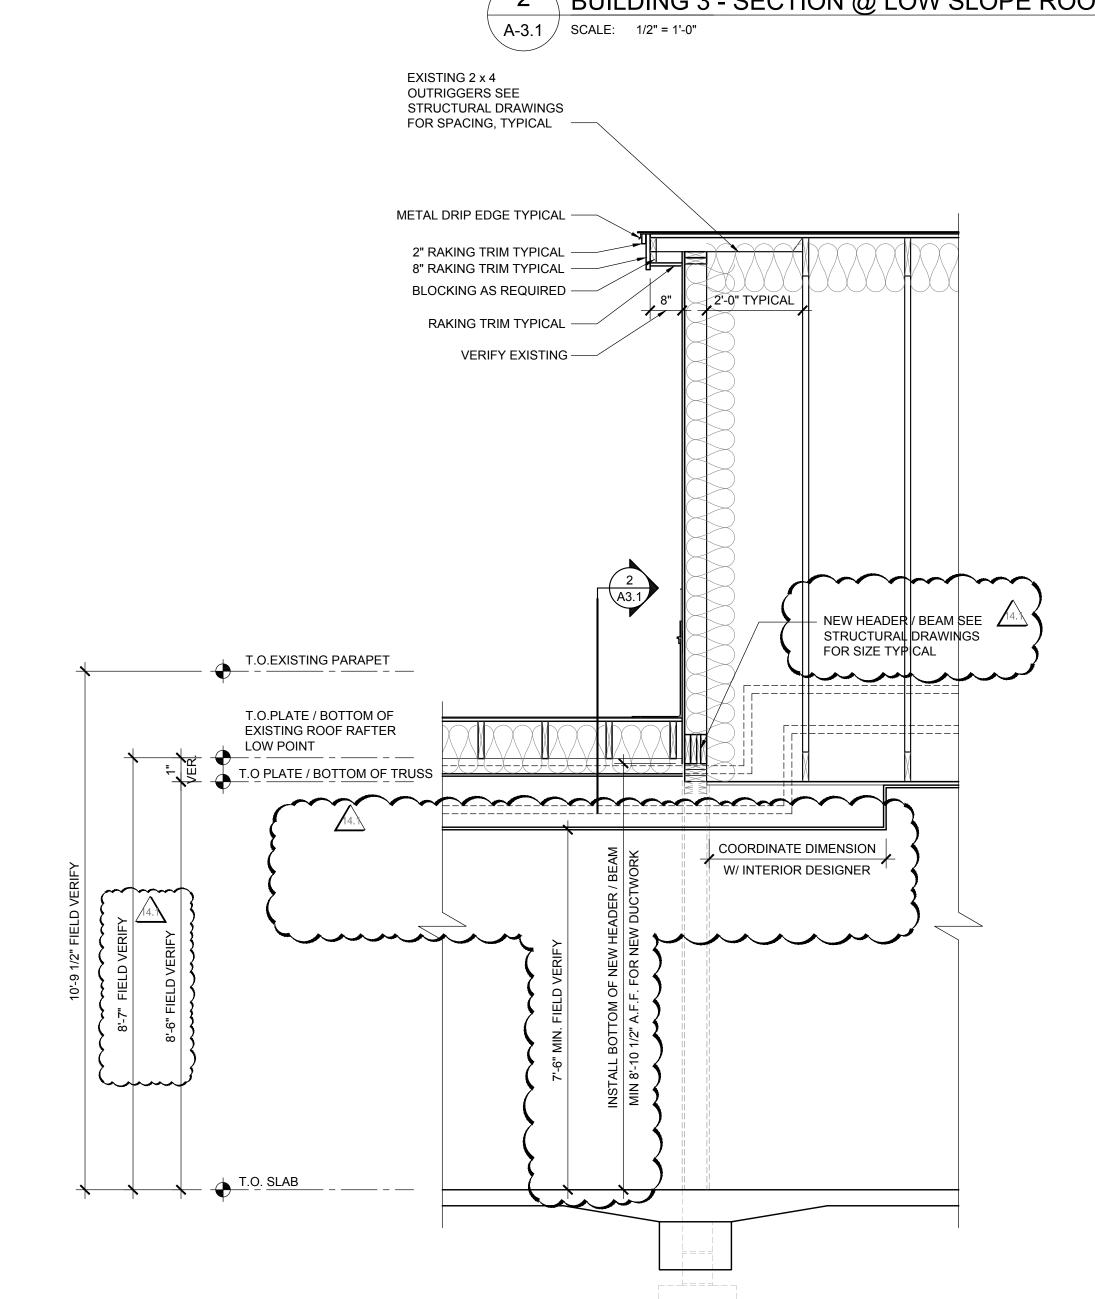

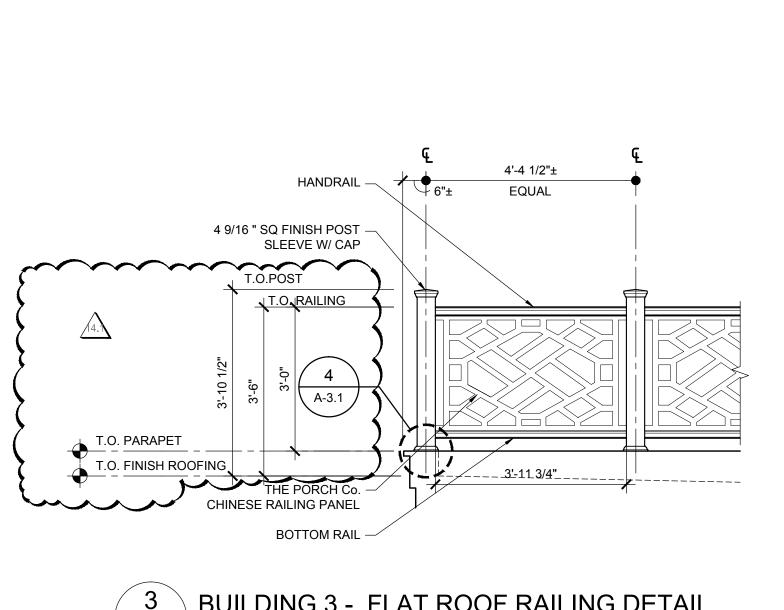

BUILDING 3 - FLAT ROOF RAILING DETAIL A-3.1 SCALE: 1/2" = 1'-0"

POST MOUNTING DETAIL A-3.1 SCALE: 3/4" = 1'-0"

-FINISH POST SLEEVE W/ BASE & CAP

- ANCHOR POST TO ROOF

WEATHER SEAL ALL PENETRATIONS FOLLOW ROOFING MANUFACTURER


RECOMMENDATIONS AND PROCEDURES

STRUCTURE W/ Fiberon POST SLEEVE SURFACE MOUNT SYSTEM ANCHOR W/ SUPPLIED WOOD LAGS

✓ 4X4 POST



Thomas E Hall & Associates, Inc. 240 Conestoga Road Wayne, Pa 19087 (610) 293-9900 www.teh-architects.com Architecture • Interiors • Planning

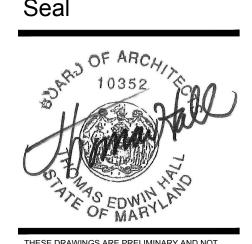

THESE DRAWINGS ARE PRELIMINARY AND NOT OFFICIAL UNTIL SIGNED AND SEALED.
CONTRACTOR SHALL VERIFY DIMENSIONS AND SITE CONDITIONS AND REPORT ANY DISCREPANCIES TO THE ARCHITECT. THE ARCHITECTS IS NOT RESPONSIBLE FOR ANY UNREPORTED DISCREPANCIES.

Consultant

Project Type Alteration

Remodel New Addition New Construction

**Drawing Status** Design Phase

Not For Construction For Pricing

For Permit Revision

For Construction

Revisions

No. Date Description 06/03/2016 REVISION #10 07/07/2016 REVISION #11 07/27/2016 REVISION #12 09/16/2016 REVISION #13 01/06/2017 REVISION #14


02/03/2017 ADDENDUM #1 Job No: 6142.00 Drawn By: 17 FEB 03


Checked By: TEH AS NOTED Scale: Drawing Title:

FLASH. & PART. DETAILS

A-4.0


**BILLINGSLEY BUILDING 3** 

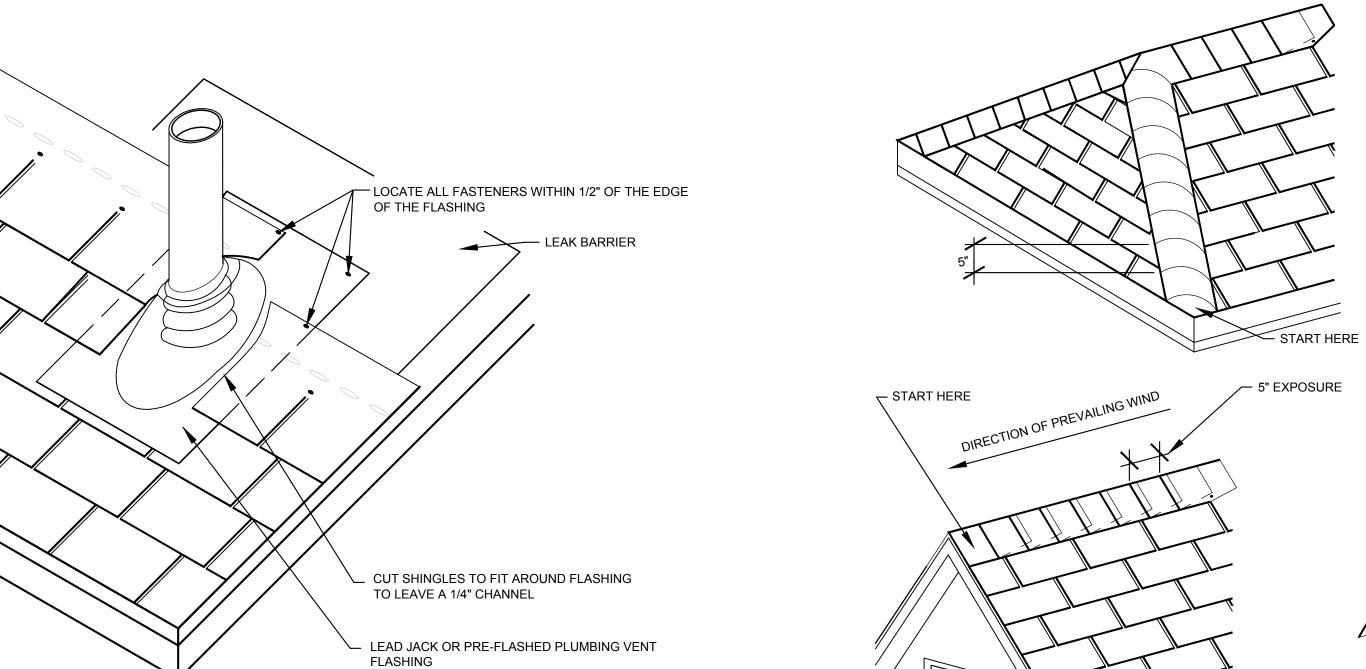


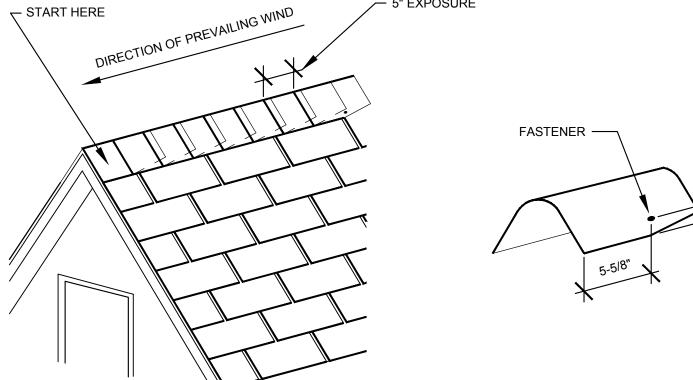

DETAIL - TYPICAL RIDGE / HIP

A-4.0 / SCALE: 1 1/2" = 1'-0"

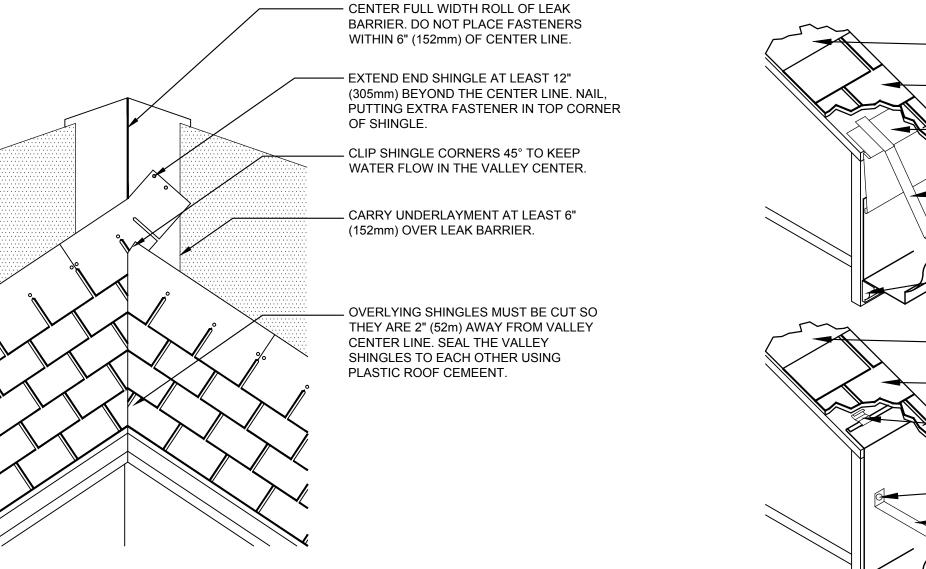


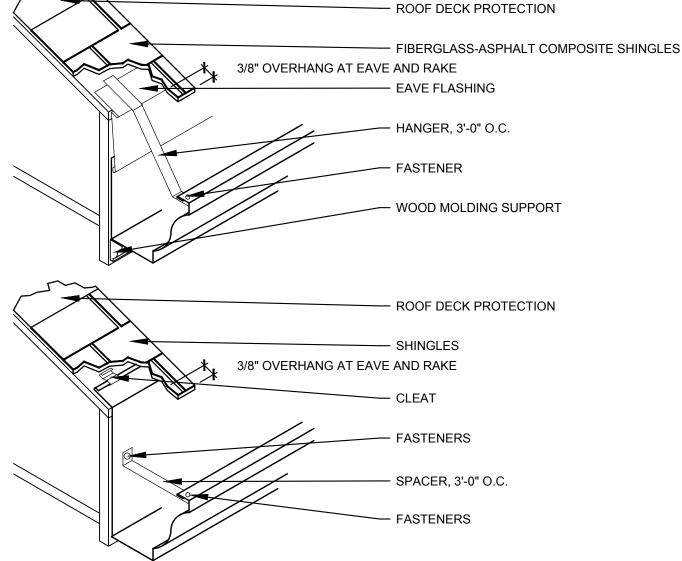


11 DETAIL - TYPICAL GUTTER INSTALLATION


A-4.0 SCALE: 1 1/2" = 1'-0"

10 DETAIL - TYPICAL WOVEN VALLEY A-4.0 SCALE: 1 1/2" = 1'-0"

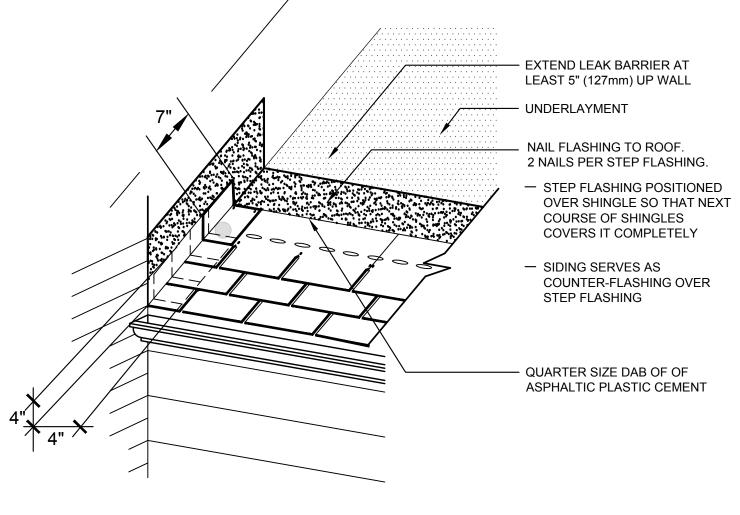





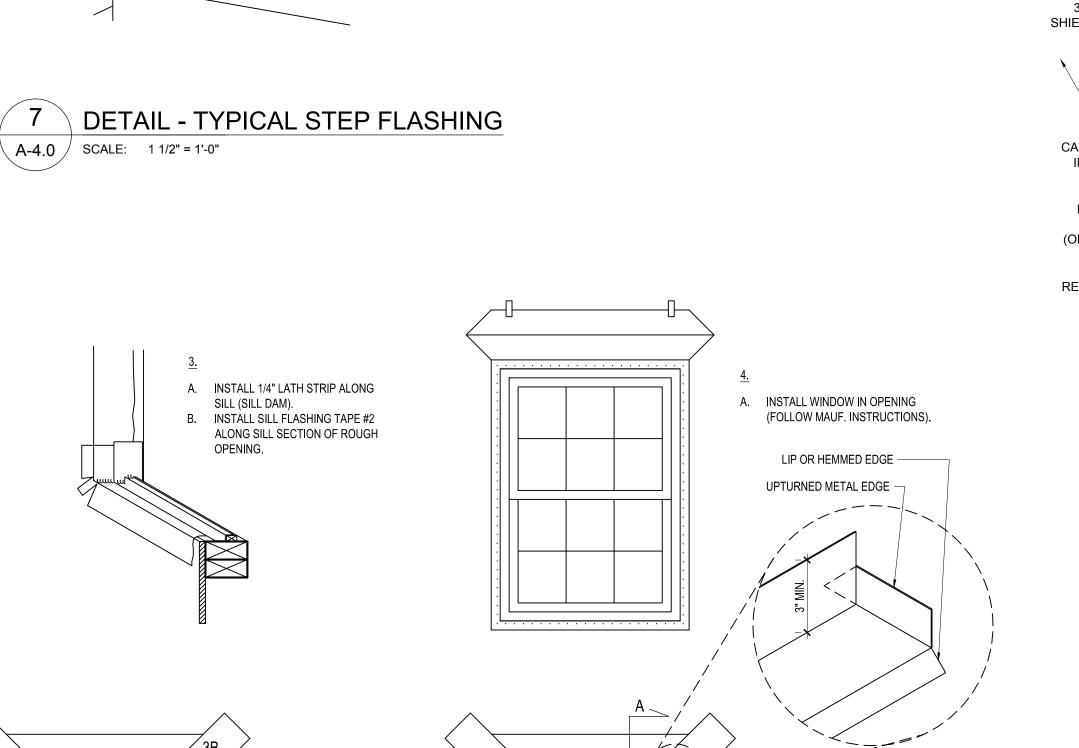

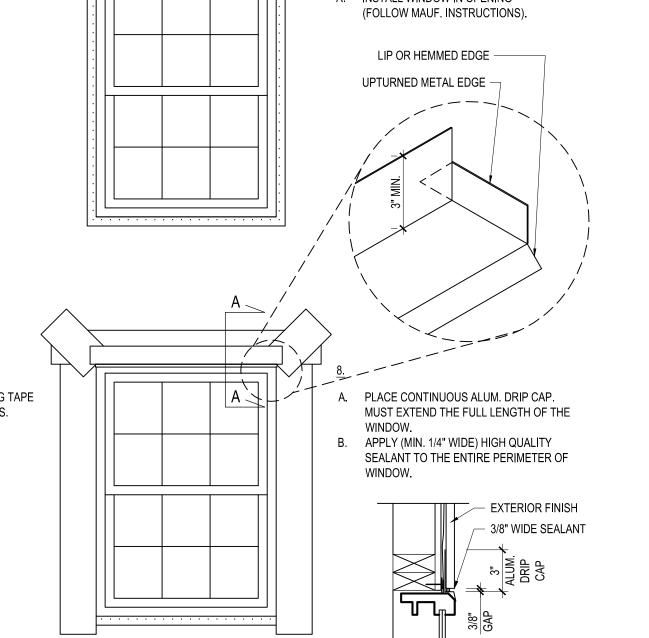


SECTION A-A

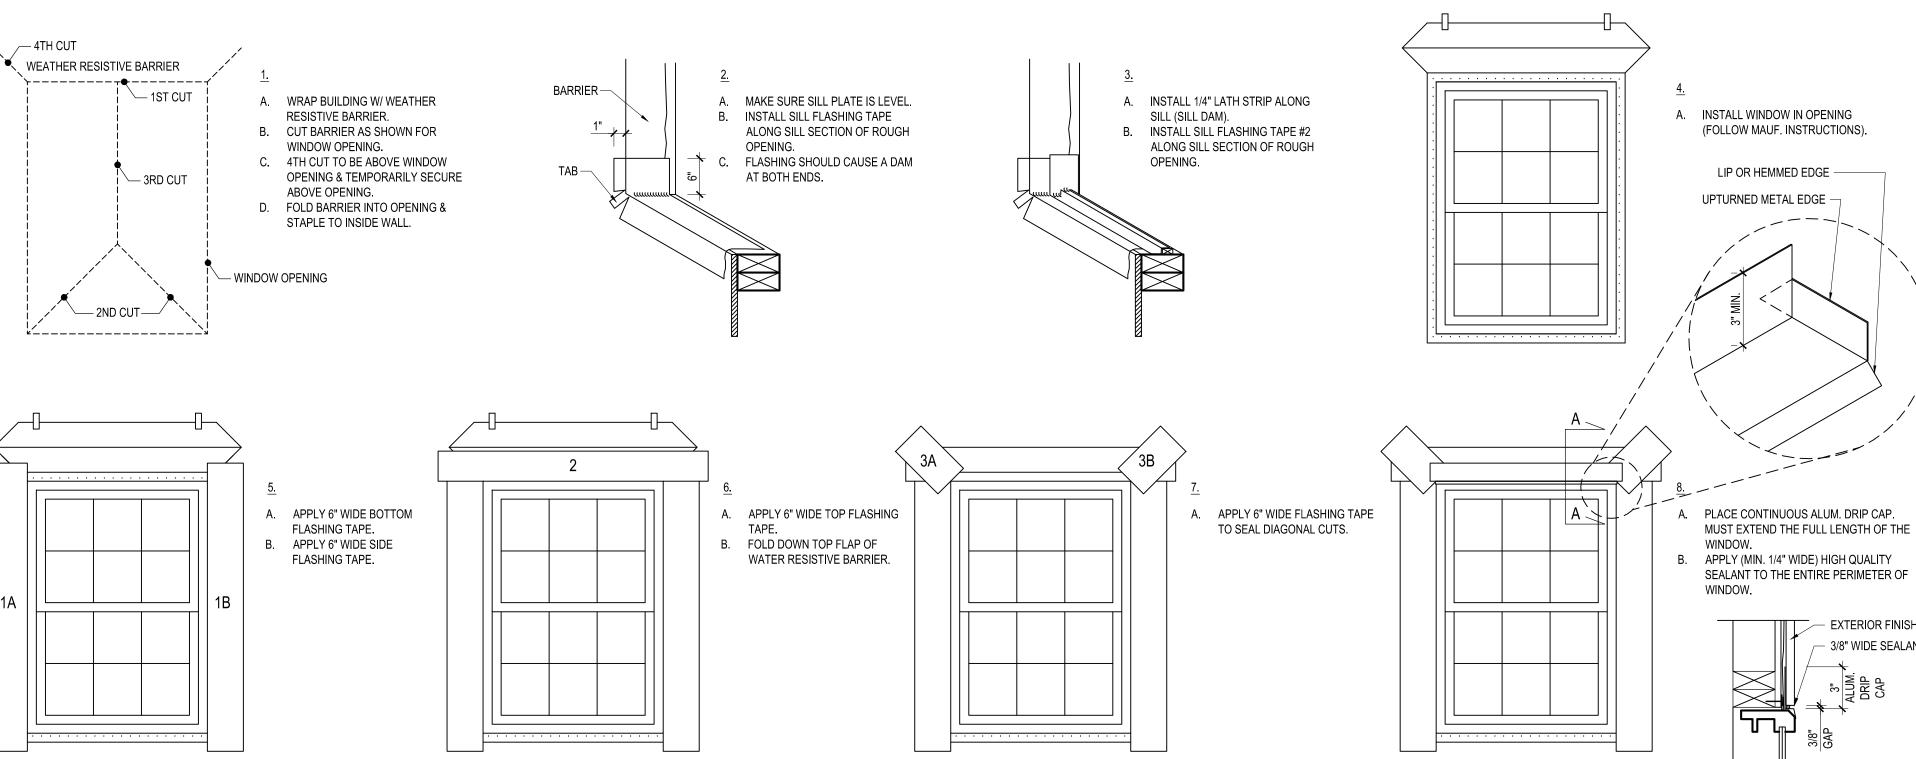

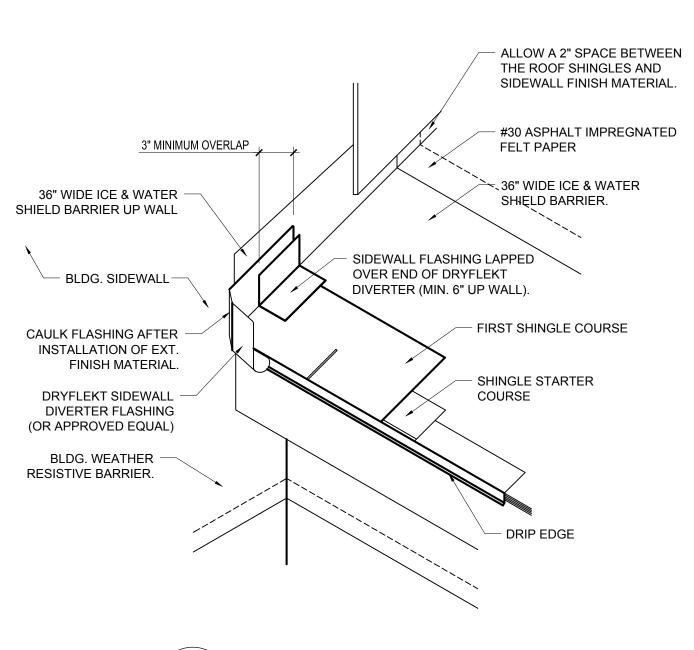



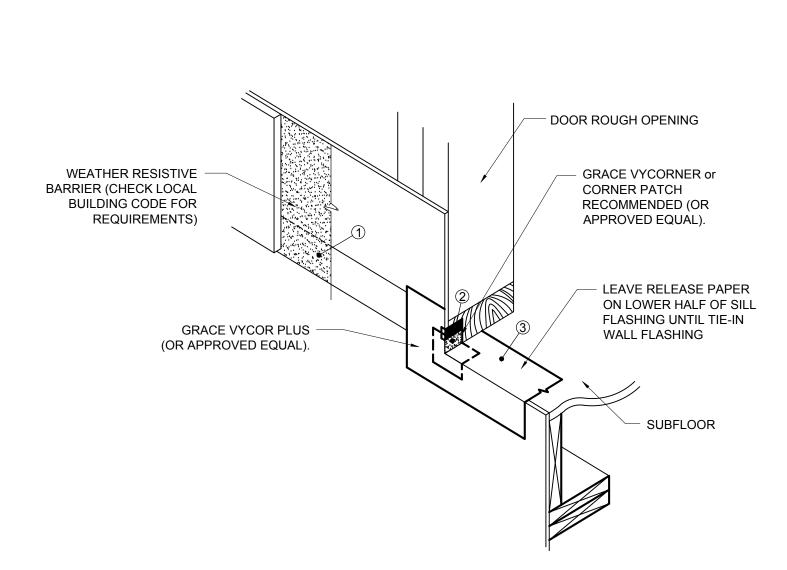

5 DETAIL - DOOR SILL FLASHING A-4.0 SCALE: 3/4" = 1'-0"

1.) INSTALL 24" LEAK BARRIER TARGET SHEET.

A-4.0 SCALE: 1 1/2" = 1'-0"

2.) DO NOT FACE NAIL THE PLUMBING VENT FLASHING.

· ALONG RAKE, PUT

PROTECTION.

∠LEAK BARRIER SHOULD EXTEND 24" (610mm) BEYOND THE INSIDE

A-4.0 SCALE: 1 1/2" = 1'-0"

WALL LINE.

NON-CORRODING METAL DRIP

EDGE ON TOP OF ROOF DECK

DETAIL - TYPICAL ROOF VENT FLASHING

DETAIL - TYPICAL UNDERLAYMENT

— WOOD DECK

COMPLETELY COVER THE DECK
 WITH TWO LAYERS OF ROOF DECK

- EXPOSURE WILL VARY DEPENDING ON UNDERLAYMENT USED. FOLLOW APPLICATION INSTRUCTIONS ON

SELECTED UNDERLAYMENT FOR

\_ALONG EAVES, PUT LEAK BARRIER

ON TOP OF NON- CORROSIVE METAL

PROTECTION AS SHOWN.

PROPER EXPOSURE.

DRIP EDGE.


- LEAK BARRIER MUST NOT

BY MORE THAN 1/4" (6mm)

OVERHANG THE EAVE EDGE




- EXTERIOR SHEATHING

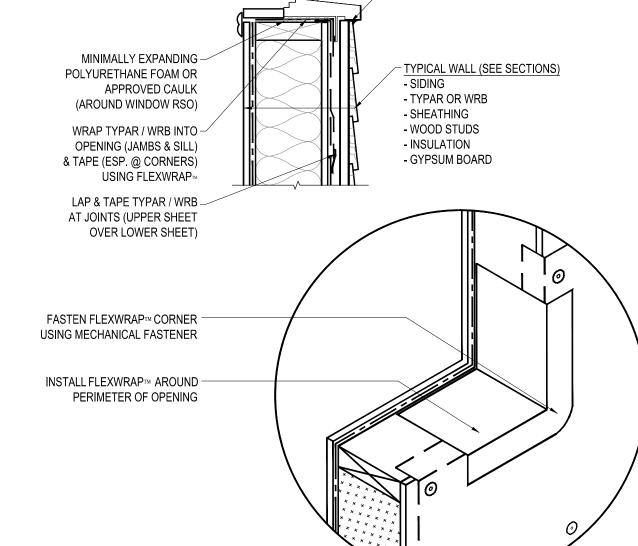


12 DETAIL - WINDOW SILL FLASHING

A-4.1 SCALE: 1-1/2" = 1'-0"

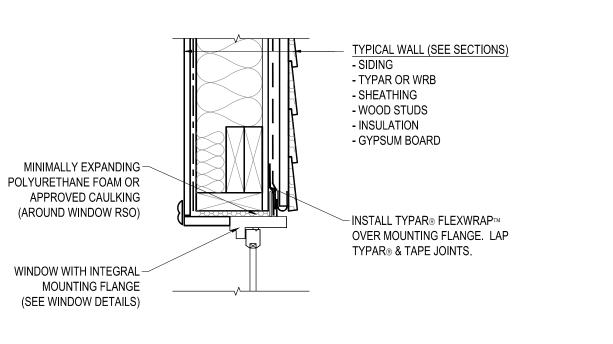


13 DETAIL - WINDOW HEAD FLASHING

SCALE: 1-1/2" = 1'-0"

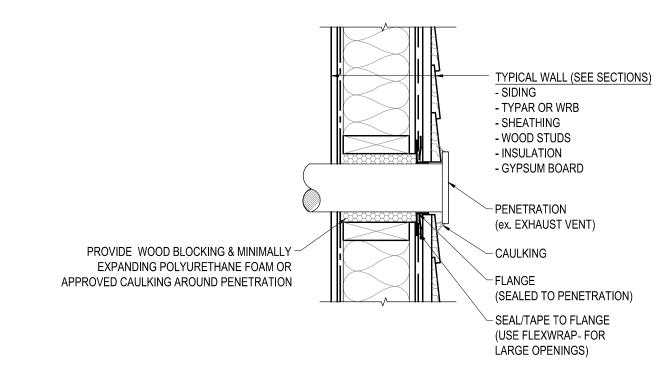


14 DETAIL - WALL PENETRATION

A-4.1 SCALE: 1-1/2" = 1'-0"

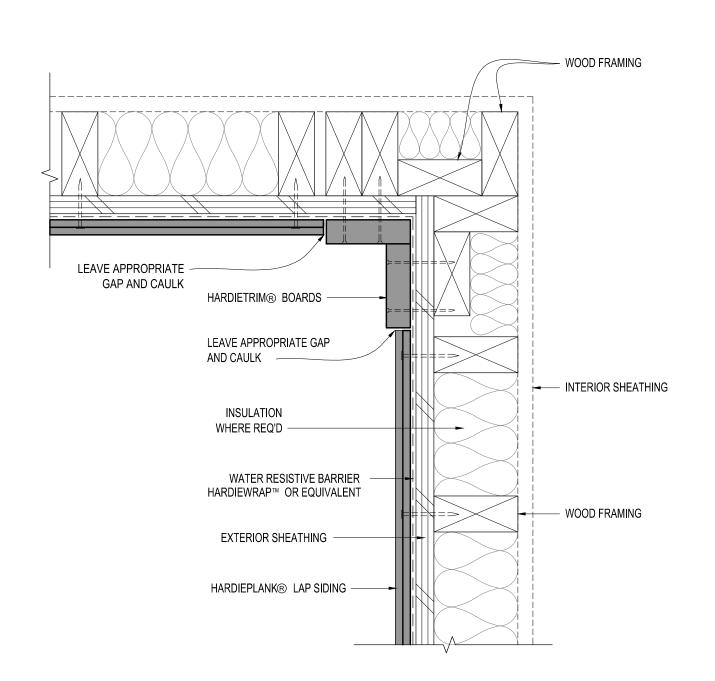


6 DETAIL - SIDING INSIDE CORNER

A-4.1 SCALE: 3" = 1'-0"

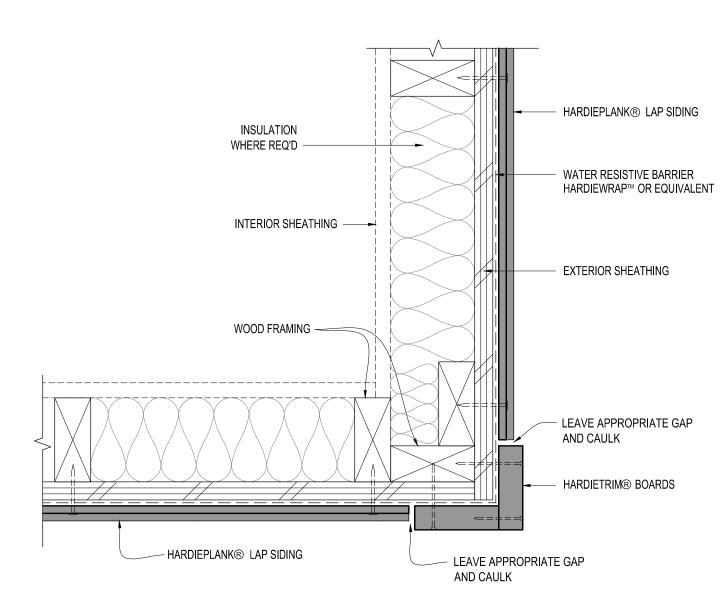


7 DETAIL - SIDING OUTSIDE CORNER

A-4.1 SCALE: 3" = 1'-0"

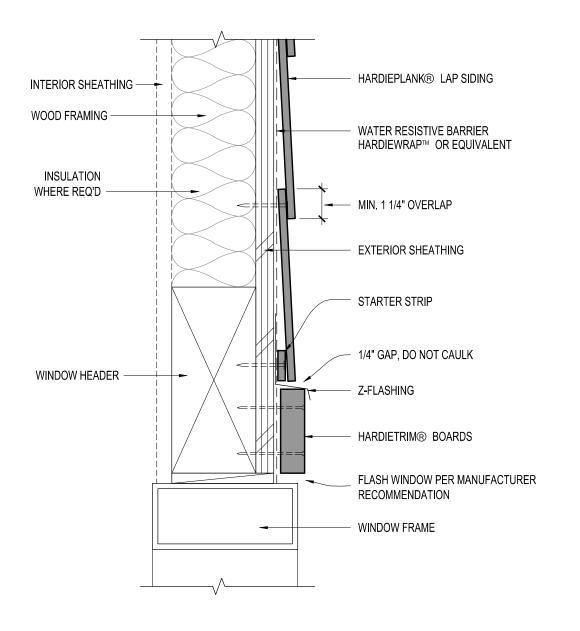


8 DETAIL - SIDING WINDOW / DOOR HEAD

A-4.1 SCALE: 3" = 1'-0"

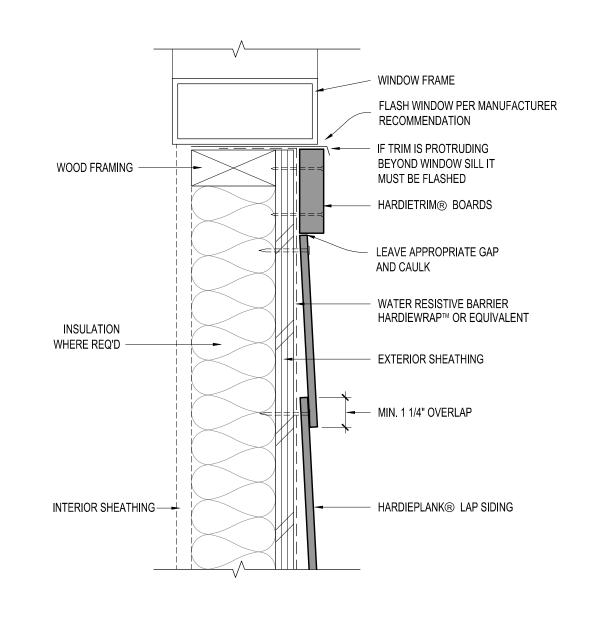


9 DETAIL - SIDING WINDOW / DOOR SILL

A-4.1 SCALE: 3" = 1'-0"

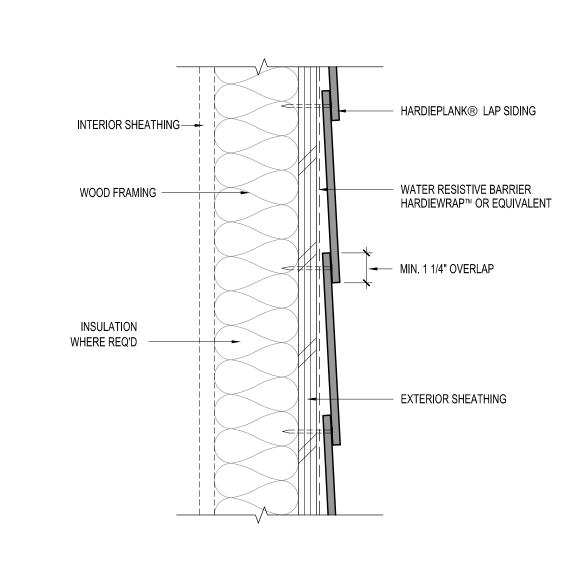


10 DETAIL - SIDING TYPICAL WALL


A-4.1 SCALE: 3" = 1'-0"

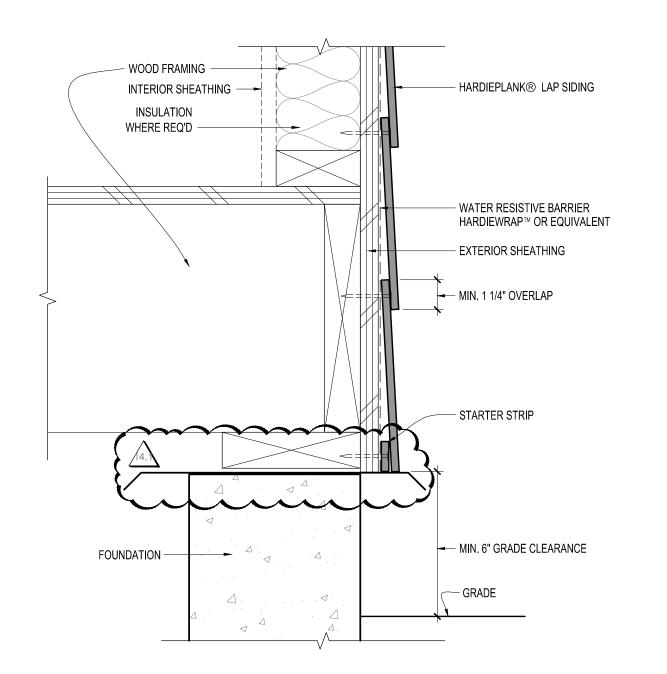

1 DETAIL - SIDING AT GRADE


SCALE: 3" = 1'-0"

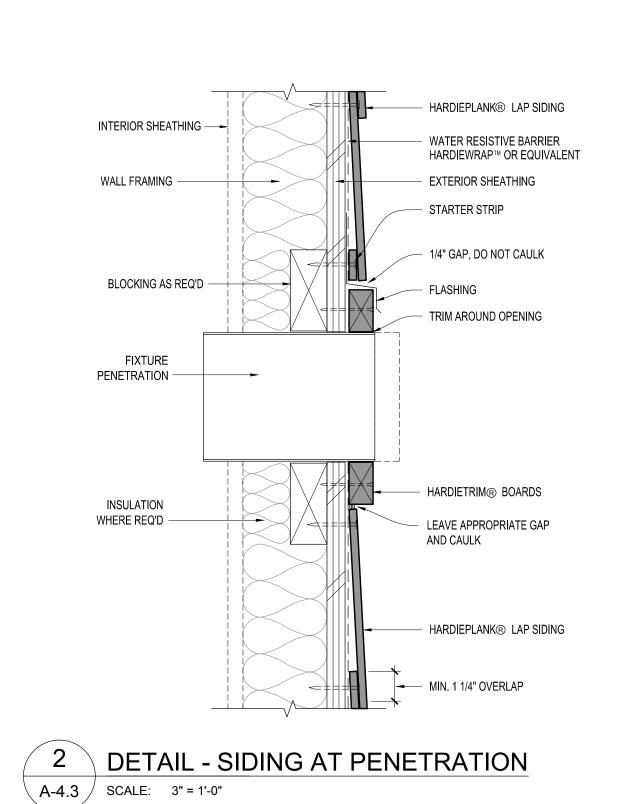

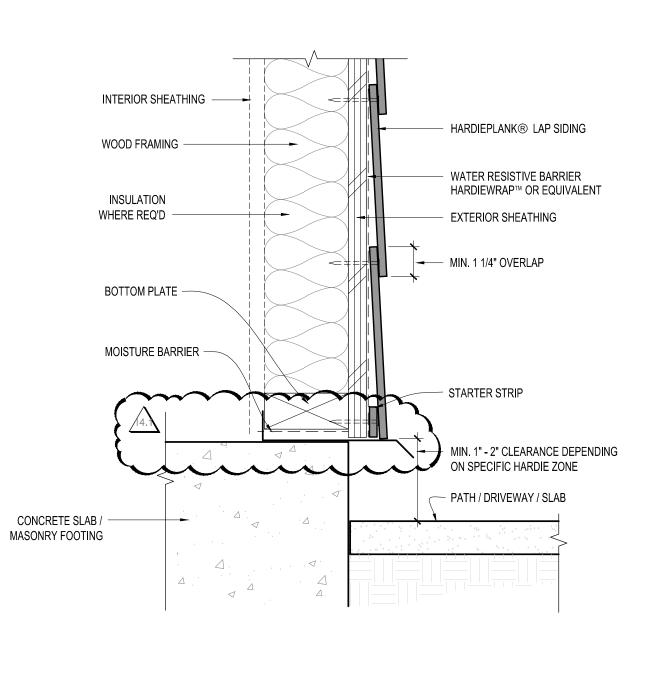


3 DETAIL - SIDING AT PATH / DRIVEWAY

A-4.3 SCALE: 3" = 1'-0"

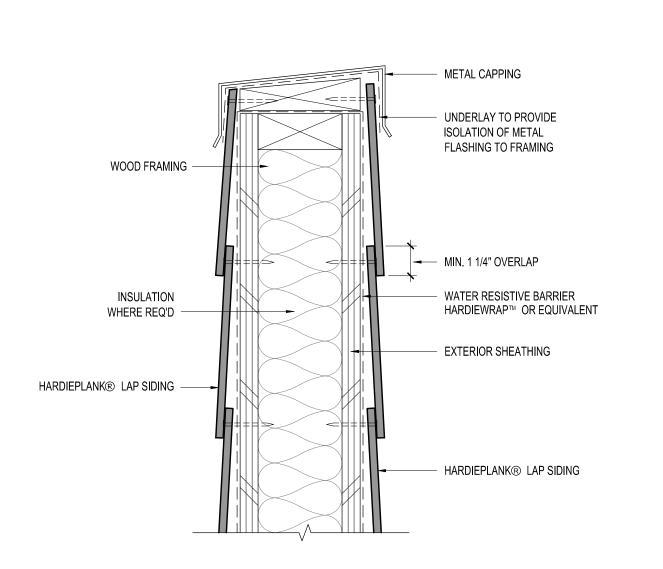

4 DETAIL - SIDING AT PARAPET WALL

A-4.3 SCALE: 3" = 1'-0"

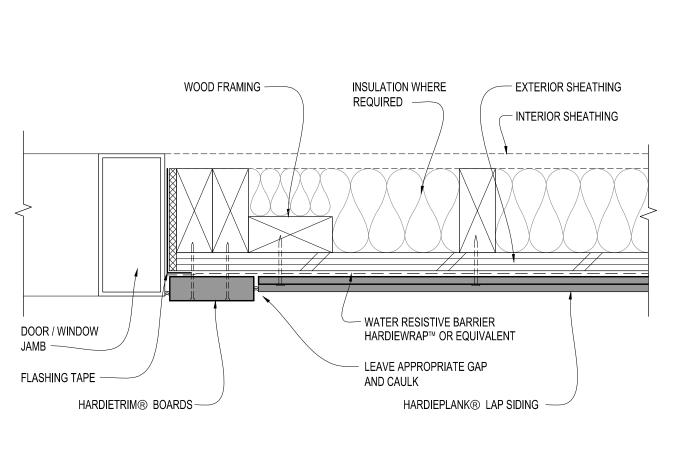

5 DETAIL - SIDING AT WINDOW / DOOR JAMB

A-4.3 SCALE: 3" = 1'-0"



Project

BILLINGSLEY
FACILITY
BUILDING 3
11,100 BILLINGSLEY
ROAD WALDORF,
MARYLAND 220602




Thomas E Hall & Associates, Inc. 240 Conestoga Road Wayne, Pa 19087 (610) 293-9900 www.teh-architects.com Architecture • Interiors • Planning

Seal



THESE DRAWINGS ARE PRELIMINARY AND NOT OFFICIAL UNTIL SIGNED AND SEALED. CONTRACTOR SHALL VERIFY DIMENSIONS AND SITE CONDITIONS AND REPORT ANY DISCREPANCIES TO THE ARCHITECT. THE ARCHITECTS IS NOT RESPONSIBLE FOR ANY UNREPORTED DISCREPANCIES.

Consultant

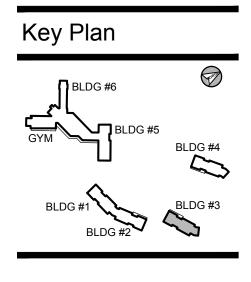

Project Type

Alteration

Remodel

New Addition

Drawing Status

New Construction

Design Phase

Not For Construction
For Pricing

For Pricing

For Permit

Revision
For Construction

Revisions

No. Date Description

06/03/2016 REVISION #10

07/07/2016 REVISION #11

07/27/2016 REVISION #12

07/27/2016 REVISION #12

09/16/2016 REVISION #13

01/06/2017 REVISION #14

02/03/2017 ADDENDUM #1

Job No: 6142.00
Drawn By:

Checked By: TEH
Date: 17 FEB 0

Date: 17 FEB 03
Scale: AS NOTED
Drawing Title:

HARDIPLANK DETAILS Sheet No:

A-4.1



Thomas E Hall & Associates, Inc. 240 Conestoga Road Wayne, Pa 19087 (610) 293-9900 www.teh-architects.com Architecture • Interiors • Planning

manne manne manner mann

2 SECTION DETAIL - TYPICAL FOLDING PARTITION

LVL SUPPORT BEAMS, SEE STRUCTURAL -

(2) LAYERS 5/8" GWB EA. SIDE, FILL CAVITY — WITH SOUND BATT INSULATION, TYPICAL

HANGER BRACKET BY MODERNFOLD —

#17 STEEL TRACK PRE-PAINTED WHITE -

PARTITION PANEL PER PLAN —

A-4.2 / SCALE: 1 1/2" = 1'-0"

STEEL, 4 WHEEL BALL BEARING TROLLEYS

DRAWINGS, TYPICAL

– WASHER PLATE @ ÉA. THRÉADÈD ROD,

SEE STRUCTURAL DRAWINGS, TYPICAL

– EXÍSTING ROÓF TRUSS, V.I.F., SEE / STRUCTURAL DRAWINGS, TYPICAL

— BAFFLE JOINTS MUST BE TAPED & SPACKLED <u>NOT BY MODERNFOLD</u> <u>OR DISTRIBUTOR</u>


– .38" DIA. A36 STEEL HANGER RODS

AND LOCKING FLANGE NUTS BY

SureSet AUTOMATIC TOP SEAL.


OPERATING RANGE: 1 3/8" ± .19"


MODERNFOLD, TYPICAL

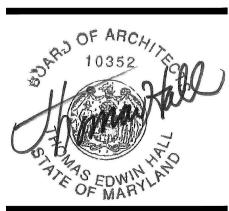

THESE DRAWINGS ARE PRELIMINARY AND NOT OFFICIAL UNTIL SIGNED AND SEALED.
CONTRACTOR SHALL VERIFY DIMENSIONS AND SITE CONDITIONS AND REPORT ANY DISCREPANCIES TO THE ARCHITECT. THE ARCHITECTS IS NOT RESPONSIBLE FOR ANY UNREPORTED DISCREPANCIES.

Consultant

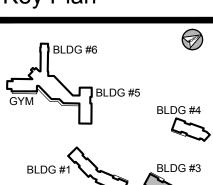

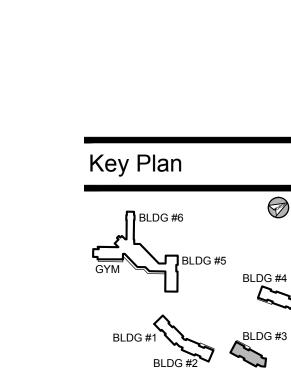

Alteration Remodel New Addition New Construction

Project Type

**Drawing Status** 

Design Phase

Not For Construction For Pricing

For Permit Revision

For Construction

Revisions


No.	Date	Description
<u>v</u>	06/03/2016	REVISION #10
$\overline{\mathbb{A}}$	07/07/2016	REVISION #11
12	07/27/2016	REVISION #12
13	09/16/2016	REVISION #13
14	01/06/2017	REVISION #14
14.1	02/03/2017	ADDENDUM #1

Drawn By: Checked By: TEH Date: 17 FEB 03 Scale: AS NOTED


Drawing Title: **FOLDING PARTITION** 

DETAILS

**BILLINGSLEY BUILDING 3** 

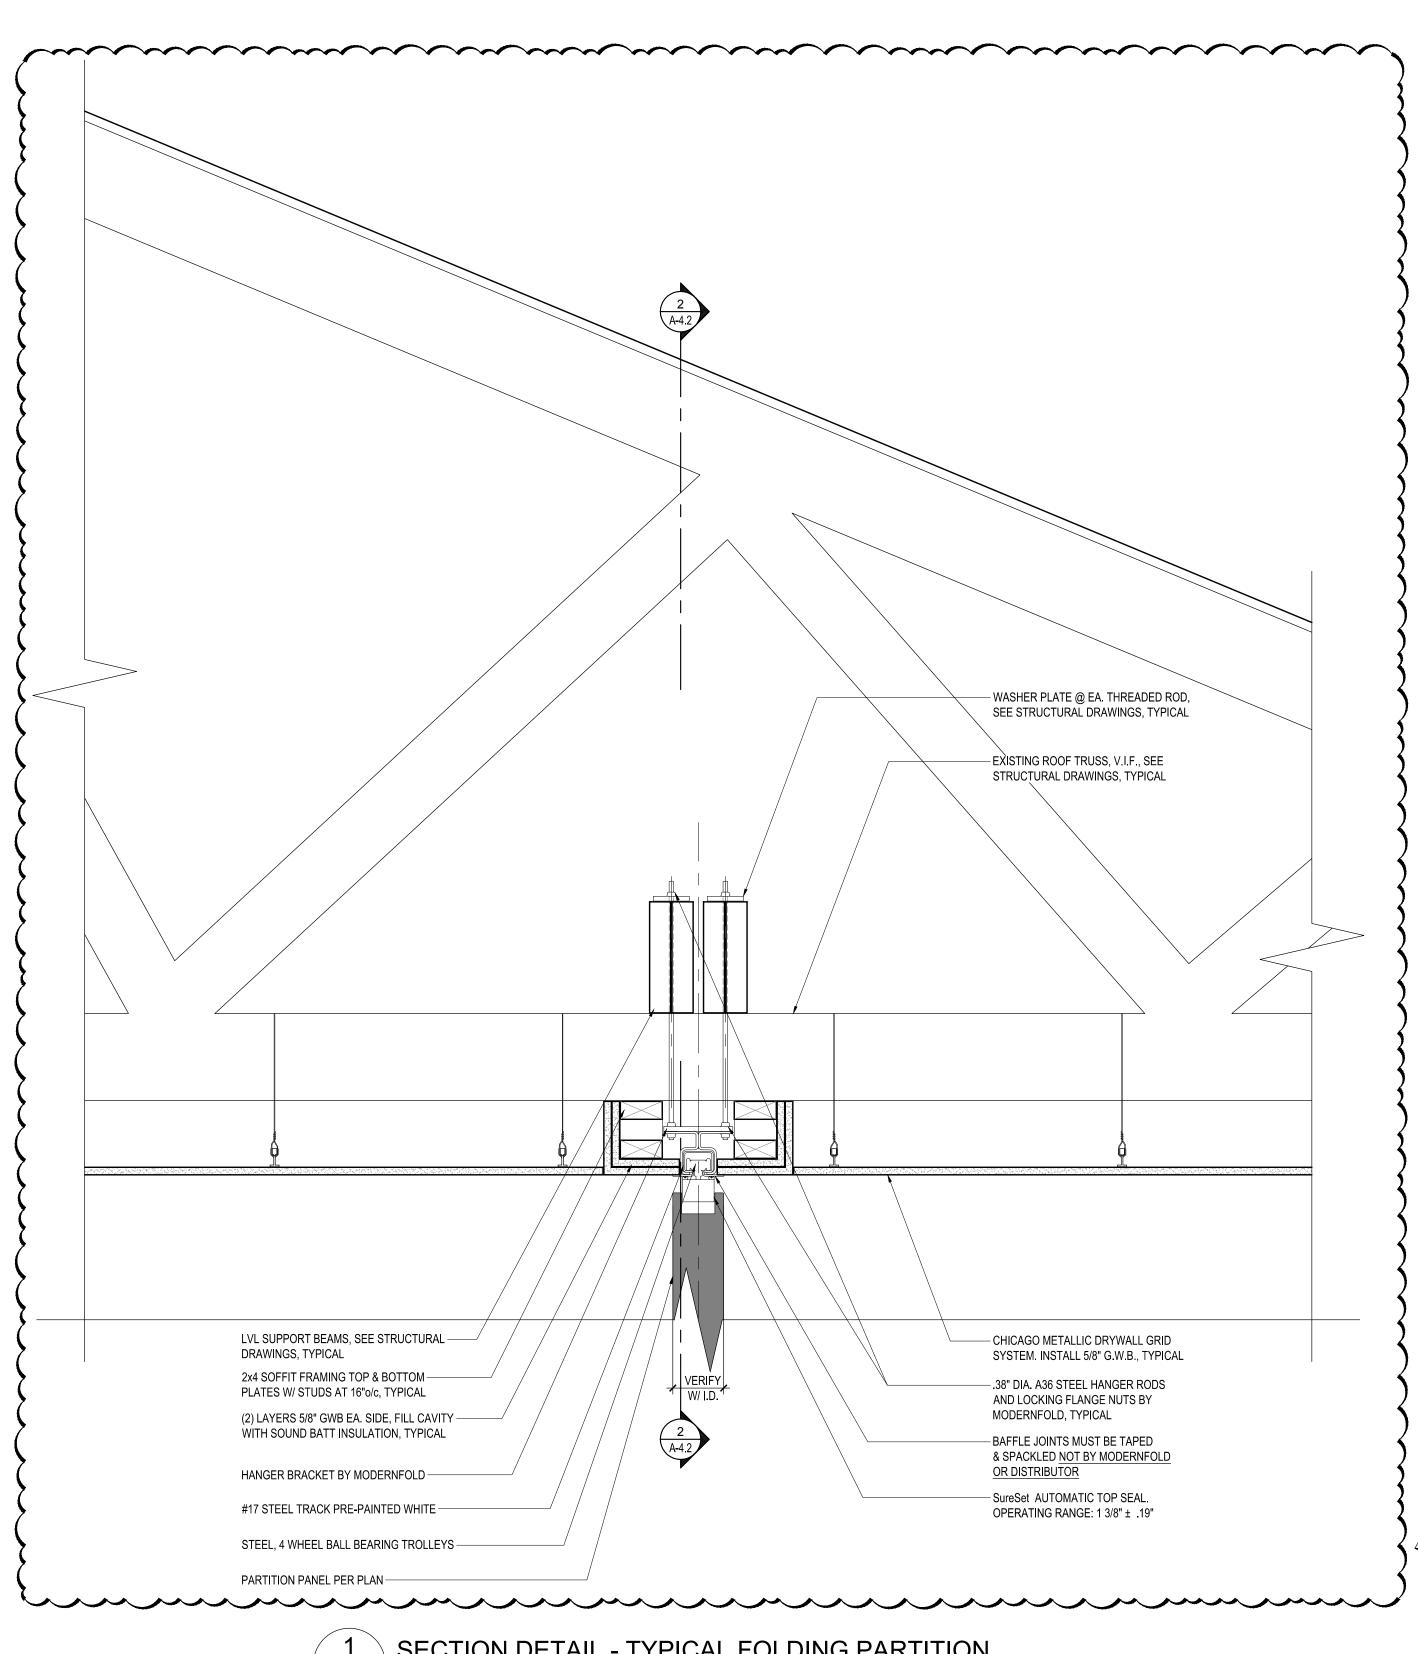

SECTION DETAIL - TYPICAL FOLDING PARTITION A-4.2 / SCALE: 1 1/2" = 1'-0"

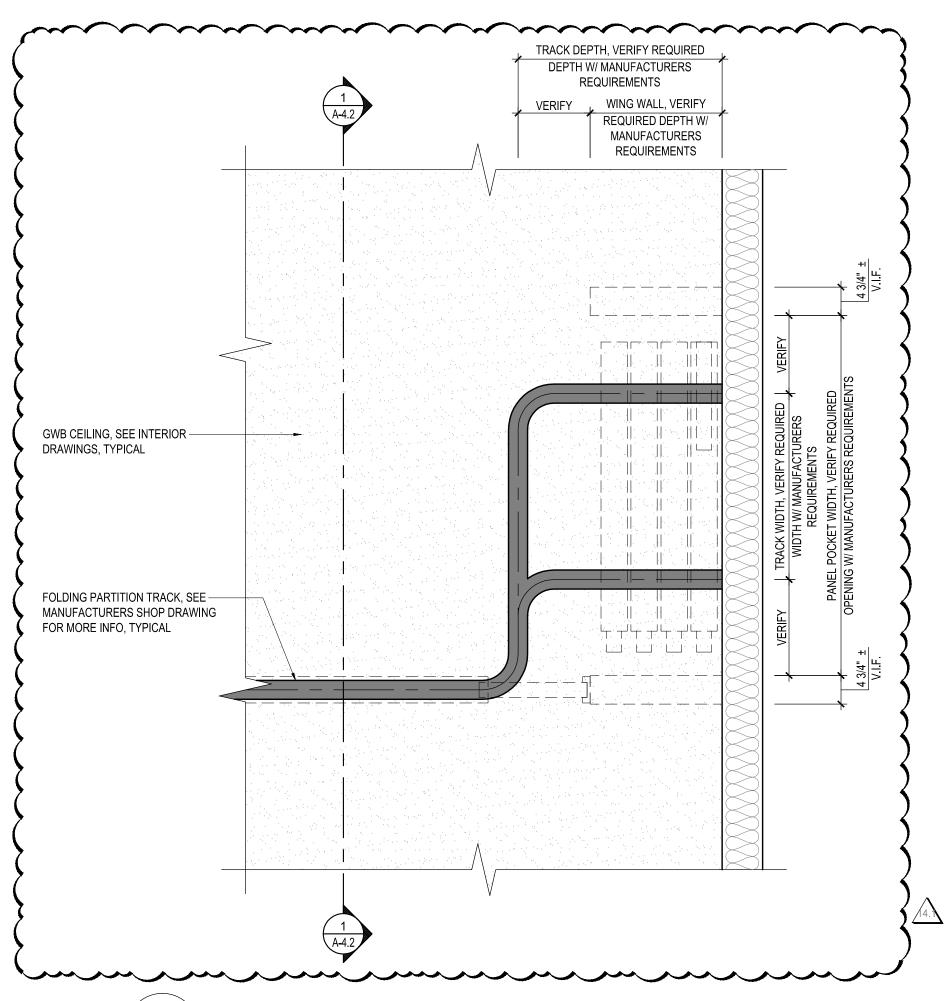


3 RCP DETAIL - TYPICAL FOLDING PARTITION

A-4.2 SCALE: 3/4" = 1'-0"

Copyright © by Thomas E. Hall & Associates, Inc., Wayne, PA 19087, Phone number (610) 293-9900. All rights reserved.

11,100 BILLINGSLEY ROAD WALDORF, MARYLAND 220602

Thomas E Hall & Associates, Inc. 240 Conestoga Road Wayne, Pa 19087 (610) 293-9900 www.teh-architects.com Architecture • Interiors • Planning

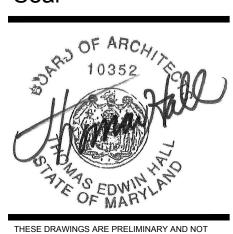

OFFICIAL UNTIL SIGNED AND SEALED.
CONTRACTOR SHALL VERIFY DIMENSIONS AND SITE CONDITIONS AND REPORT ANY DISCREPANCIES TO THE ARCHITECT. THE ARCHITECTS IS NOT RESPONSIBLE FOR ANY UNREPORTED DISCREPANCIES.

Consultant

SEALANT AS INDICATED G.C. TO VERIFY SHIM SPACE AND COORDINATE WITH BUILDING ENVELOPE WRAP, HEAD, JAMB AND SILL FLASHING. AS

RECOMMENDED BY

MANUFACTURER'S

Project Type Alteration

Remodel New Addition New Construction

**Drawing Status** 

Design Phase Not For Construction

For Pricing For Permit

> Revision For Construction

Revisions


No. Date 06/03/2016 REVISION #10 07/07/2016 REVISION #11 12 05/28/2016 REVISION #12 13 09/16/2016 REVISION #13 01/06/2017 REVISION #14

02/03/2017 ADDENDUM #1 Job No: 6142.00 Drawn By: FJF Checked By: TEH Date: 17 FEB 03


AS NOTED Scale: Drawing Title:

WINDOW SCHEDULES


Sheet No:

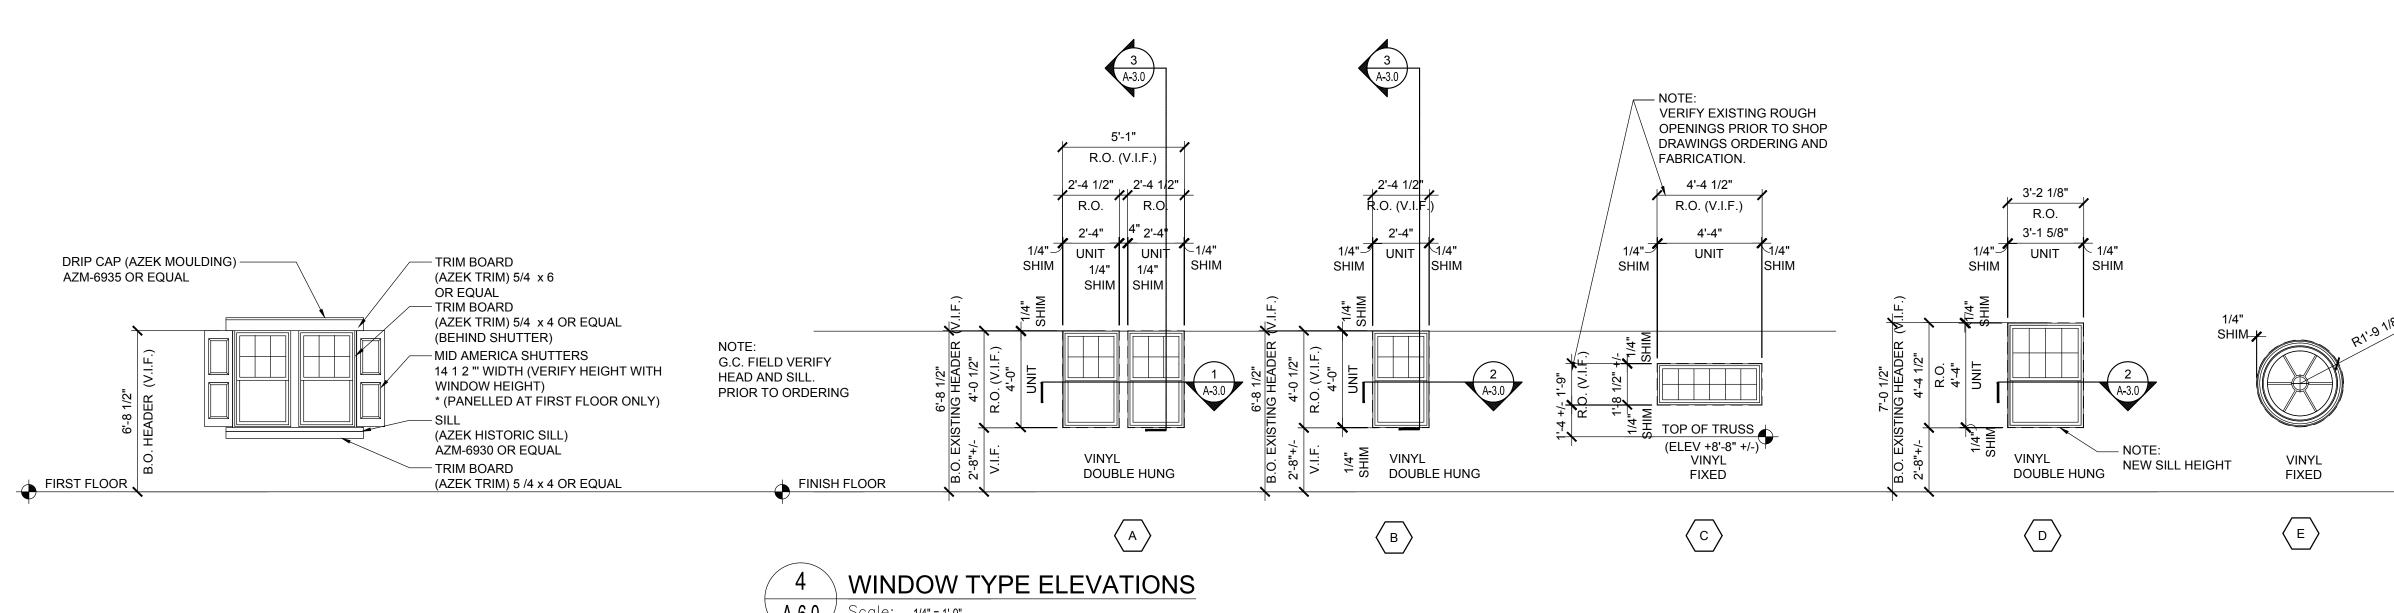


**A-6.0** Scale: 1/4" = 1'-0"

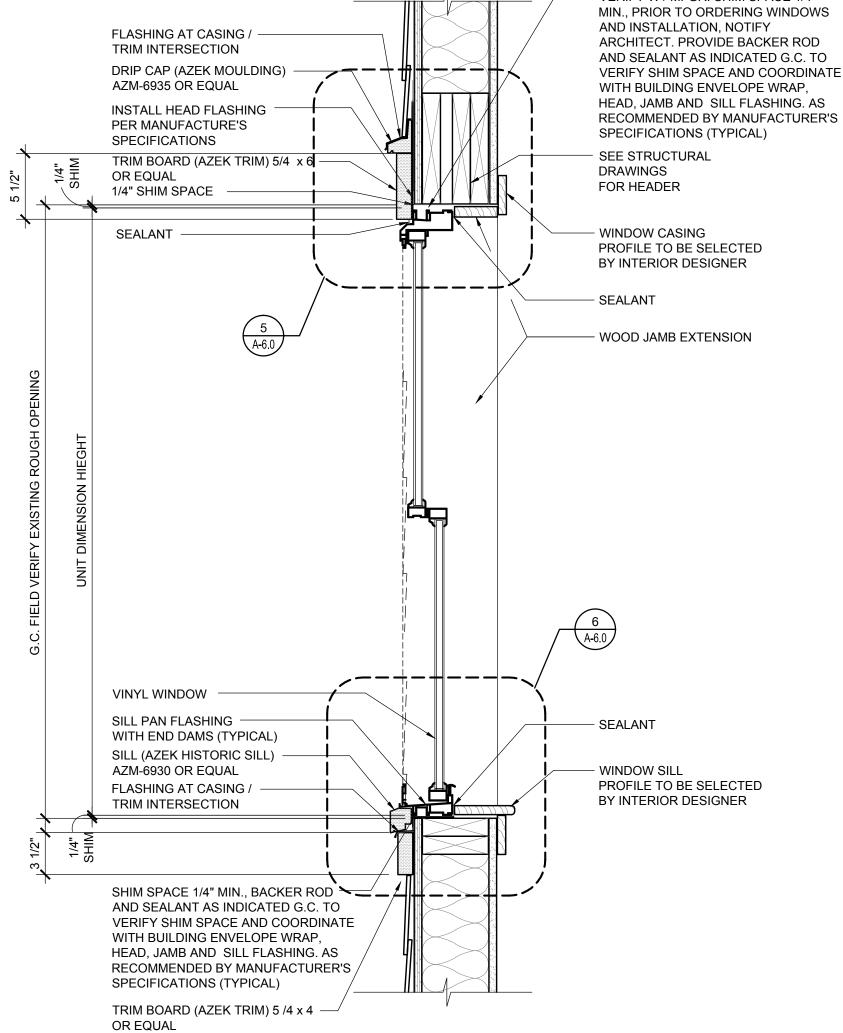

VERTICAL SECTION (HEAD, RAIL & SILL) A-6.0 Scale: 1 1/2" = 1'-0"

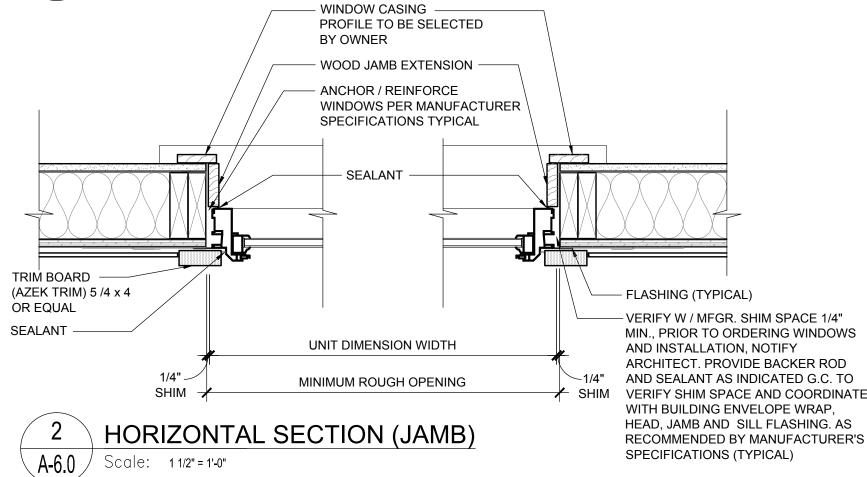

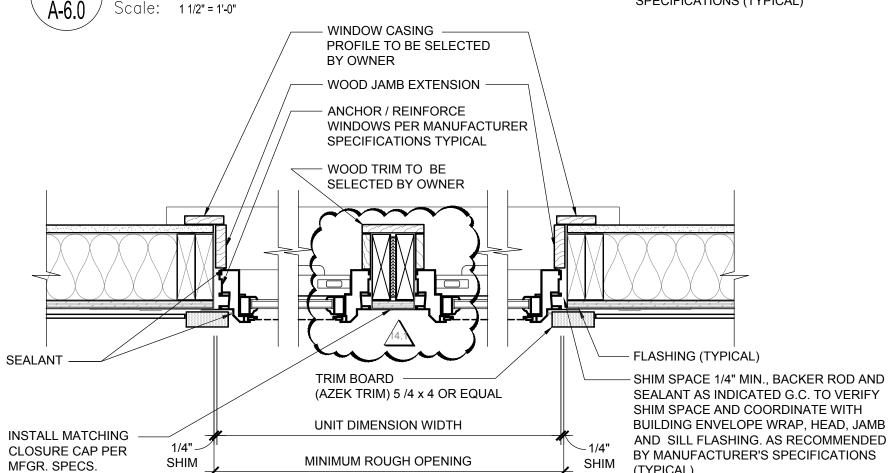

HORIZONTAL SECTION (JAMB @ DOUBLE WINDOW)


RECOMMENDED BY MANUFACTURER'S

- VERIFY W / MFGR. SHIM SPACE 1/4"

BUILDING ENVELOPE — INSTALL HEAD FLASHING PER MANUFACTURE'S SPECIFICATIONS

- VERIFY W / MFGR. SHIM SPACE 1/4" MIN., PRIOR TO ORDERING WINDOWS AND INSTALLATION, NOTIFY ARCHITECT. PROVIDE BACKER ROD AND SEALANT AS INDICATED G.C. TO VERIFY SHIM SPACE AND COORDINATE WITH BUILDING ENVELOPE WRAP, HEAD, JAMB AND SILL FLASHING. AS RECOMMENDED BY MANUFACTURER'S SPECIFICATIONS (TYPICAL)



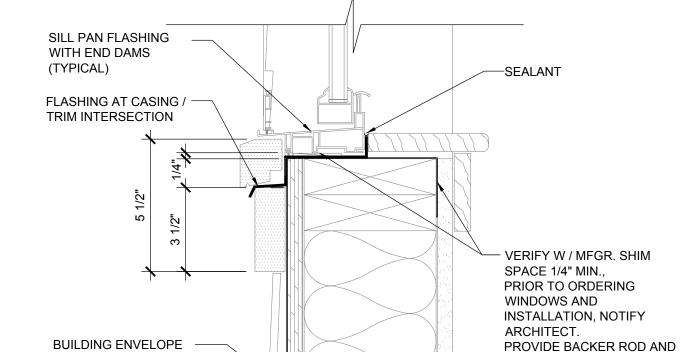

SPECIFICATIONS (TYPICAL) 6 VERTICAL SECTION (SILL)

**A-6.0** Scale: 3" = 1'-0"

E = EXISTING ROUGH OPENING N = NEW ROUGH OPENING SEE SHEET A-6.0 FOR MORE INFORMATION WINDOW NOTES NOTE:

- VERIFY IN FIELD ALL ROUGH OPENINGS, SHIM SPACE INDICATED WITH MANUFACTURER SPECIFICATIONS AND COORDINATE WITH FLASHING THICKNESS AT HEAD, JAMB,

AND SILL TYPICAL, PRIOR TO ORDERING WINDOWS.

- PROVIDE CUSTOM JAMB EXTENSIONS AS REQUIRED.

- PROVIDE INTERIOR TRIM PROFILES AS SELECTED BY OWNER. - ALL DOUBLE HUNG WINDOWS 4" MAX. OPENINGS ,SDL, VINYL ,FULL HEIGHT SCREENS AND INSULATED LOW-E

- ALL DOUBLE HUNG AND FIXED WINDOWS MODELED AFTER (SOFT - LITE ) VINYL WINDOWS.

GLAZING. WHERE SILL IS BELOW 18" FROM THE FLOOR AND

ADJACENT TO DOORS TEMPERED GLASS MUST BE USED..

- FIELD VERIFY ALL WINDOW / ENTRANCE OPENINGS PRIOR TO FABRICATION OF WINDOW FRAMES. - ALL GLAZING TO BE 1" INSULATED GLASS - ANY GLAZING

EXTENDING BELOW 18" TO BE TEMPERED.

BE TEMPERED GLASS. - NEW ALUMINUM DOORS REPLACING EXISTING DOORS -KEEP SWINGS OUTWARD IN SAME DIRECTION AS EXISTING.

- ALL GLAZING AT DOORS, SIDE LIGHTS AND TRANSOMS TO

- ALL EXISTING WINDOW SILLS AND HEAD HEIGHTS TO REMAIN. EXCEPT WHERE NOTED. ALL STOREFRONT WINDOWS - ALL WINDOWS TO HAVE CONTINUOUS METAL FLASHING AT HEAD, SILL, AND JAMBS.


> - EXISTING WINDOW / ENTRANCE SYSTEMS TO REMAIN -CLEAN, REPAIR AND RESTORE TO GOOD WORKING ORDER.

NOTIFY OWNER AND ARCHITECT IF REPLACEMENT IS

- VERIFY HARDWARE STYLE, COLOR, MATERIAL, WITH

OWNER PRIOR TO ORDERING.

_		İ	<del>                                     </del>			B00=						<del>  _</del> _	
DOOR NO.	ROOM NAME	WIDTH	HEIGHT	THICK	MAT.	DOOR FINISH	ТҮРЕ	MAT.	FRAME FINISH	TYPE	HDWR	FIRE   RATING	REMARKS
1-100.1	COFFEE SHOP / LOUNGE	(2) 3'-0"	7'-0"	1-3/4"	AL/GL	PTD	F	AL	PTD	02	1.0		EXTERIOR DOOR, SEE NOTE 23, SM CLOSERS / FINISH: BLACK ANODIZED ALUMINUM
1-100.1	GOTTLE SHOT / LOUNCE	(=) 0 0	7-0	1-0/4	AL/OL	110	'		110	02	1.0		EXTERIOR DOOR, SEE NOTE 23, SM CLOSER / FINISH: BLACK ANODIZED
1-100.2	COFFEE SHOP / LOUNGE	3'-0"	7'-0"	1-3/4"	AL/GL	PTD	E	AL	PTD	01	2.0		ALUMINUM
1-101	OFFICE	3'-0"	7'-0"	1-3/4"	WD	PTD	М	НМ	PTD	15	6.0	20 MIN	SURFACE MOUNTED CLOSER
1-102	OFFICE	3'-0"	7'-0"	1-3/4"	WD	PTD	М	HM	PTD	15	6.0	20 MIN	SURFACE MOUNTED CLOSER
1-103	OFFICE	3'-0"	7'-0"	1-3/4"	WD	PTD	М	НМ	PTD	15	6.0	20 MIN	SURFACE MOUNTED CLOSER
1-104	OFFICE	3'-0"	7'-0"	1-3/4"	WD	PTD	М	HM	PTD	15	6.0	20 MIN	SURFACE MOUNTED CLOSER
1-105	OFFICE	3'-0"	7'-0"	1-3/4"	WD	PTD	М	НМ	PTD	15	6.0	20 MIN	SURFACE MOUNTED CLOSER
1-106	OFFICE	3'-0"	7'-0"	1-3/4"	WD	PTD	M	HM	PTD	15	6.0	20 MIN	SURFACE MOUNTED CLOSER
1-107	COPY RM.	N/A 2'-10"+/- (V.I.F.)	N/A 6'-8" +/- (V.I.F.)	N/A	N/A	N/A	N/A	N/A	N/A	N/A	N/A		EXTERIOR DOOR, SEE NOTE 23,
1-108	SPRINKLER RM.	, ,	, ,	1-3/4"	MTL HM-I	PTD	C	HM	PTD	01	3.0	4.110110	SM CLOSER
1-109	SERVER RM.	3'-0"	7'-0"	1-3/4"	WD	PTD	M	HM	PTD	15	5.1	1 HOUR	SURFACE MOUNTED CLOSER
1-110	OFFICE	3'-0"	7'-0"	1-3/4"	WD	PTD	M	HM	PTD	15	6.0	20 MIN	SURFACE MOUNTED CLOSER
1-111	OFFICE	3'-0"	7'-0"	1-3/4"	WD	PTD	M	HM	PTD	15	6.0	20 MIN	SURFACE MOUNTED CLOSER
1-112	OFFICE	3'-0"	7'-0"	1-3/4"	WD	PTD	M	HM	PTD	15	6.0	20 MIN	SURFACE MOUNTED CLOSER
1-113 1-114	OFFICE  EXIST, MECH, RM,	3'-0" 2'-10"+/- (V.I.F.)	7'-0" 6'-8"+/- (V.I.F.)	1-3/4"	WD MTL HM-I	PTD PTD	M C	HM HM	PTD PTD	15 01	3.0	20 MIN	SURFACE MOUNTED CLOSER  EXTERIOR DOOR, SEE NOTE 23, SM CLOSER
1-115	GROUP MEETING RM.	3'-0"	7'-0"	1-3/4"	WD/GL	PTD	N	HM	PTD	15	7.0	20 MIN	SURFACE MOUNTED CLOSER
1-116	FILE RM.	3'-0"	7'-0"	1-3/4"	WD	PTD	M	HM	PTD	15	5.0	1 HOUR	SURFACE MOUNTED CLOSER
1-117	OFFICE	3'-0"	7'-0"	1-3/4"	WD	PTD	M	HM	PTD	15	6.0	20 MIN	SURFACE MOUNTED CLOSER
1-118	GROUP MEETING RM.	3'-0"	7'-0"	1-3/4"	WD/GL	PTD	N	HM	PTD	15	7.0	20 MIN	SURFACE MOUNTED CLOSER
1-118.1	GROUP MEETING RM.												FOLDING PARTITION SUBMIT SHOP DRAWINGS
1-119	GROUP MEETING RM.	3'-0"	7'-0"	1-3/4"	WD/GL	PTD	N	НМ	PTD	15	7.0	20 MIN	SURFACE MOUNTED CLOSER
1-120	MENS TOILET RM.	3'-0"	7'-0"	1-3/4"	WD	PTD	M	НМ	PTD	15	8.0	20 MIN	60" LONG PULL AND PUSH PULL WITH SM CLOSER
1-121	WOMENS TOILET RM.	3'-0"	7'-0"	1-3/4"	WD	PTD	M	НМ	PTD	15	8.0	20 MIN	1 HOUR 60" LONG PULL AND PUSH PULL WITH SM CLOSER
1-122	STORAGE	3'-0"	7'-0"	1-3/4"	WD	PTD	M	HM	PTD	15	5.0	1 HOUR	SURFACE MOUNTED CLOSER
1-122A	JAN. CL.	3'-0"	7'-0"	1-3/4"	WD	PTD	М	НМ	PTD	15	5.0	1 HOUR	SURFACE MOUNTED CLOSER
1-123	GROUP MEETING RM.	3'-0"	7'-0"	1-3/4"	WD/GL	PTD	N	НМ	PTD	15	7.0	20 MIN	SURFACE MOUNTED CLOSER
1-123.1	GROUP MEETING RM.												FOLDING PARTITION SUBMIT SHOP DRAWINGS
1-124	GROUP MEETING RM.	3'-0"	7'-0"	1-3/4"	WD/GL	PTD	N	НМ	PTD	15	7.0	20 MIN	SURFACE MOUNTED CLOSER
1-125	FURN. STOR.	3'-0"	7'-0"	1-3/4"	WD	PTD	М	НМ	PTD	15	5.0	1 HOUR	1 HOUR RATED DOOR / SM CLOSER
1-126	GROUP MEETING RM.	3'-0"	7'-0"	1-3/4"	WD/GL	PTD	N	НМ	PTD	15	7.0	20 MIN	SURFACE MOUNTED CLOSER FOLDING PARTITION SUBMIT SHOP
1-126.1	GROUP MEETING RM.												DRAWINGS
1-127	GROUP MEETING RM.	3'-0"	7'-0"	1-3/4"	WD/GL	PTD	N	НМ	PTD	15	7.0	20 MIN	SURFACE MOUNTED CLOSER
1-128	OFFICE	3'-0"	7'-0"	1-3/4"	WD	PTD	М	НМ	PTD	15	6.0	20 MIN	SURFACE MOUNTED CLOSER
1-129	OFFICE	3'-0"	7'-0"	1-3/4"	WD	PTD	М	НМ	PTD	15	6.0	20 MIN	SURFACE MOUNTED CLOSER
1-130	OFFICE	3'-0"	7'-0"	1-3/4"	WD	PTD	М	НМ	PTD	15	6.0	20 MIN	SURFACE MOUNTED CLOSER
1-131	OFFICE	3'-0"	7'-0"	1-3/4"	WD	PTD	M	НМ	PTD	15	6.0	20 MIN	SURFACE MOUNTED CLOSER
		2			,,,,,,		_						EXTERIOR DOOR, SEE NOTE 23, SM CLOSER / FINISH: BLACK ANODIZED
1-132	CORRIDOR	3'-0"	7'-0"	1-3/4"	AL/GL	PTD	E	AL	PTD	01	2.0		ALUMINUM
1-133	CORRIDOR	N/A	N/A	N/A	N/A	N/A	N/A	N/A	N/A	N/A	N/A		EXTERIOR DOOR, SEE NOTE 23,
1-134	CORRIDOR	3'-0"	7'-0"	1-3/4"	AL/GL	PTD	E	AL	PTD	01	2.0		SM CLOSER / FINISH: BLACK ANODIZED  ALUMINUM
1-134A	CORRIDOR	(2) 2'-10"	7'-0"	1-3/4"	WD/GL	PTD	Q	НМ	PTD	17	4.0	1 HOUR	"SMOKE BARRIER" , OPPOSING SWING, RT DOOR, HOLD OPEN, CLOSER SEE HARDWARE SCHEDULE
1-135	CORRIDOR	N/A	N/A	N/A	N/A	N/A	N/A	N/A	N/A	N/A	N/A		HARDWAKE SUMEDULE
1-135	CORRIDOR	N/A N/A	N/A N/A	N/A N/A	N/A N/A	N/A N/A	N/A N/A	N/A N/A	N/A N/A	N/A N/A	N/A N/A		
1-130	CORRIDOR	IN/A	IN/A	IN/A	IN/A	IV/A	IN/A	IV/A	IN/A	IV/A	IN/A		EXTERIOR DOOR,
A-100	ATTIC ACCESS DOOR	3-0"+/- (V.I.F.)	5'-0" +/- (V.I.F.)	1-3/4"	MTL HM-I	PTD	С	НМ	PTD	01	3.1		SM CLOSER / GC TO VERIFY EXISTING OPENING

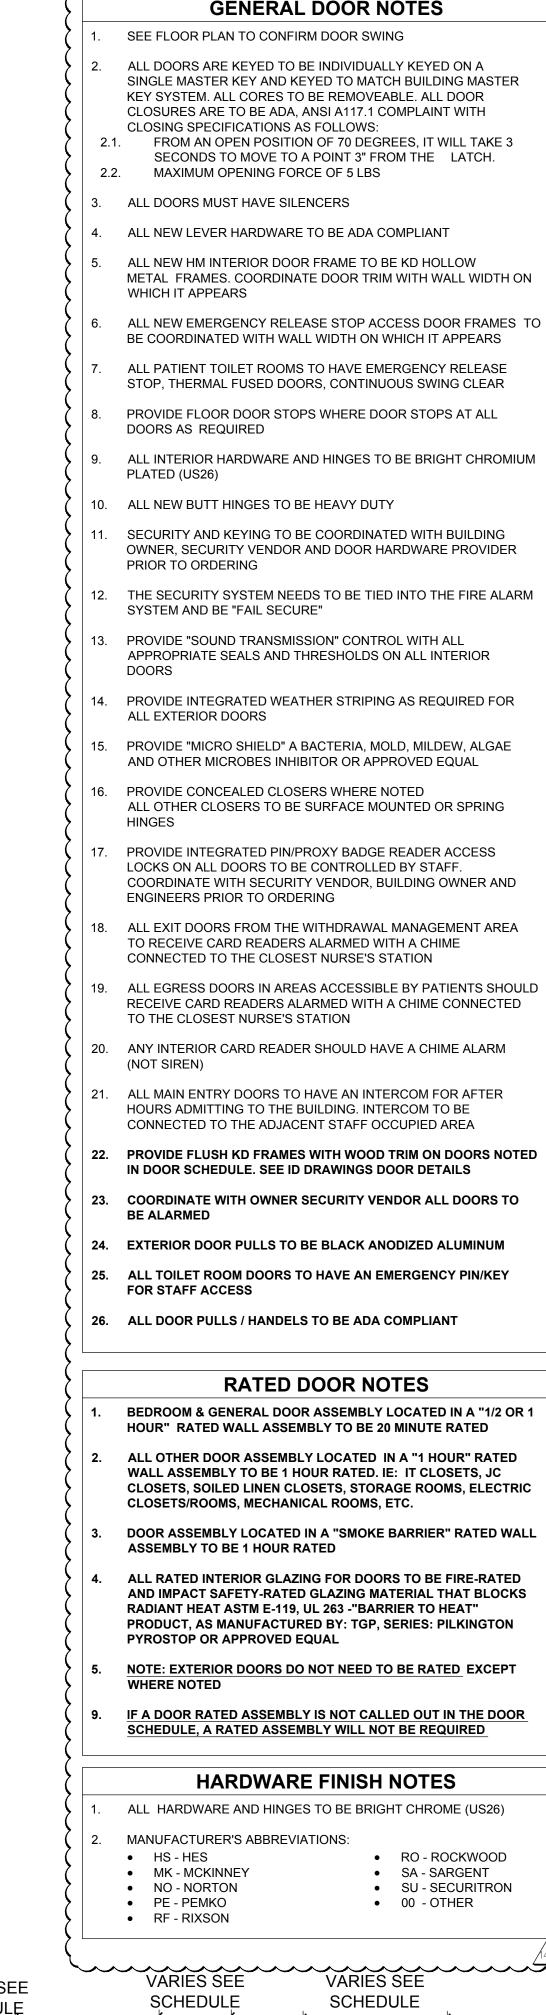

Recovery Centers of America

BILLINGSLEY

11,100 BILLINGSLEY

MARYLAND 220602

Γhomas E Hall & Associates, Inc.

Architecture • Interiors • Planning

THESE DRAWINGS ARE PRELIMINARY AND NOT

OFFICIAL UNTIL SIGNED AND SEALED.
CONTRACTOR SHALL VERIFY DIMENSIONS AND SITE CONDITIONS AND REPORT ANY DISCREPANCIES TO THE ARCHITECT. THE

ARCHITECTS IS NOT RESPONSIBLE FOR ANY

UNREPORTED DISCREPANCIES.

⟨Consultant⟩

∛Key Plan

Remodel

For Construction

Description

17 FEB 03 AS NOTED


240 Conestoga Road


√ www.teh-architects.com

**〈** Wayne, Pa 19087 **〈**(610) 293-9900

 $\$  ROAD WALDORF,

**₹FACILITY** 

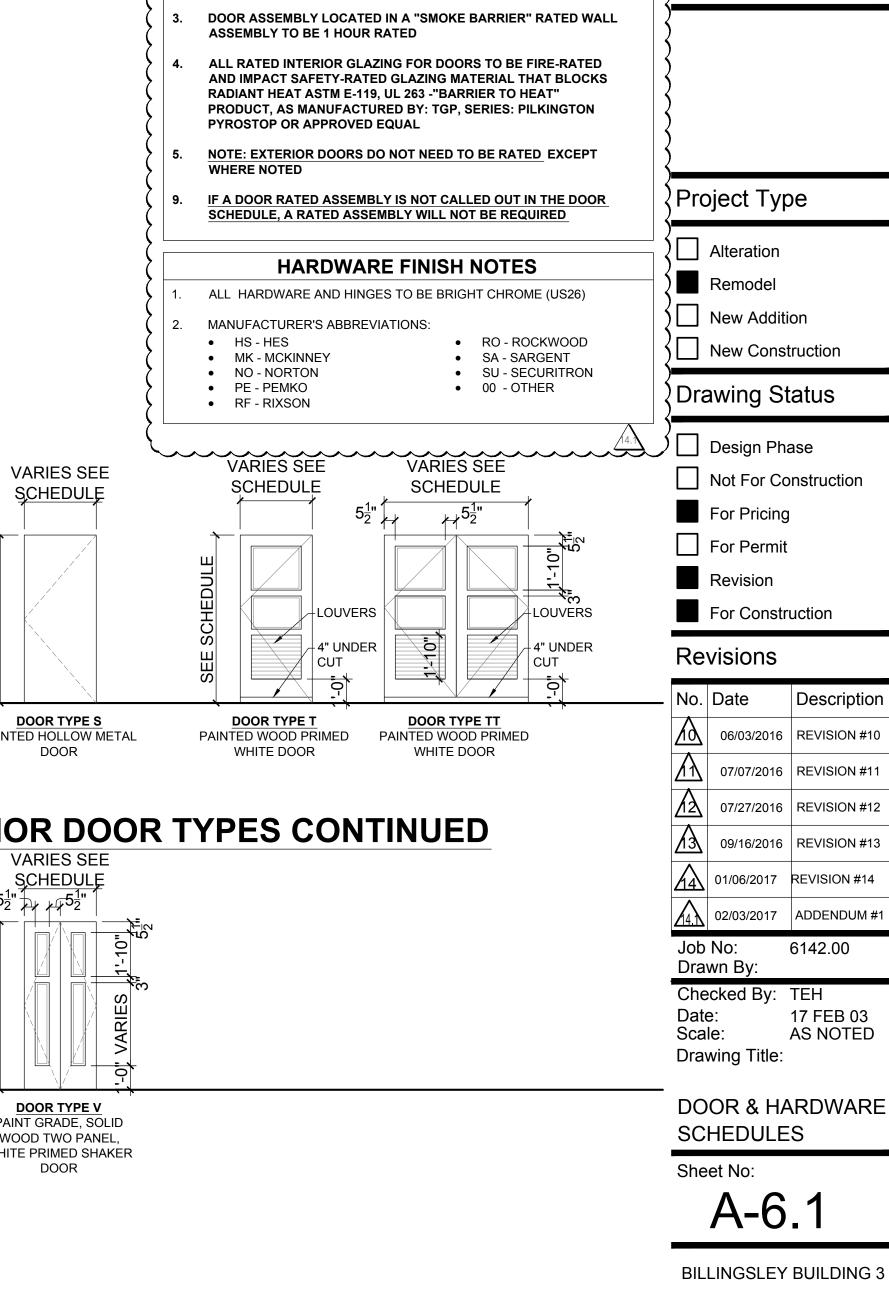

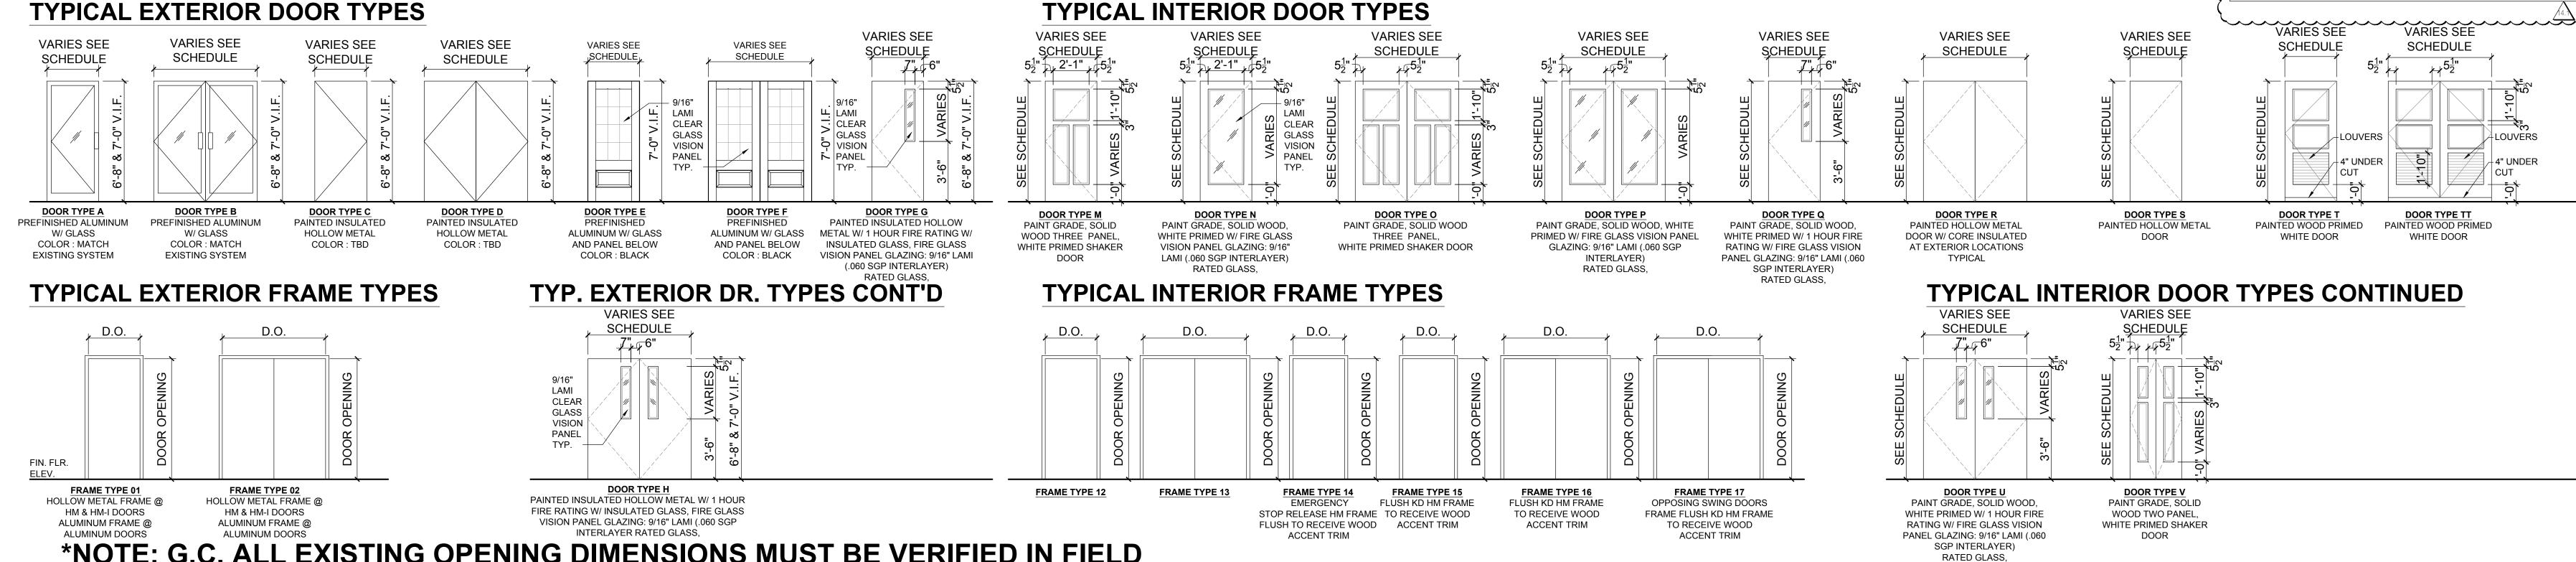

\*NOTE: G.C. ALL EXISTING OPENING DIMENSIONS MUST BE VERIFIED IN FIELD

A-6.1

### <u> Hardware Schedule</u>

	<b>Set: 1.0</b>		
Doors: 1-100.1			
6 Hinge (heavy weight)	T4A3786	US26	MK
2 Pivot Set	147 BLACK	622	RF
2 Pivot	EM19 QC-12 BLACK	622	RF
1 Concealed Vert Rod Exit	LC SG 43 55 56 AD8410 106 BLACK	US20D	SA
1 Exit Device	LC SG 43 55 56 AD8410	US20D	SA
1 Cylinder	DG1 63 42/ 34 BLACK	US20D	SA
2 Pull	RM3301-72 (or 96' if reqd) MP BLACK	315	RO
2 Concealed Overhead Holder/Stop	6-X36 BLACK	622	RF
2 Door Operator	6020 D BLACK	693	NO
1 Threshold	273x3AFG MSES10SS		PE
1 Gasketing	By Door Manufacturer		00
2 Sweep	307APK		PE
2 ElectroLynx Harness	QC-C1500P		MK
2 eLynx Door Harness	QC-C*** (Length / Type as Require	ed)	MK
2 Position Switch	DPS-M-BK By Security Vendor		SU
1 Power Supply	BPS (size & type as required)		SU

Notes: OUTSIDE OPERATION: DURING NORMAL HOURS PUSHING OUTSIDE PUSH BUTTON UNLOCKS EXIT DEVICES AND ACTIVATES OPERATORS. AFTER HOURS OUTSIDE PUSH BUTTON IS NOT ACTIVE. INSIDE OPERATION: PUSHING PUSH BUTTON WILL UNLOCK EXIT AND ACTIVATE OPERATOR. EGRESS IS BY EXIT DEVICE. EGRESS IS BY EXIT DEVICE WHICH ACTIVATES

ALARM (CHIME) AT NURSES DESK. EMERGENCY ACCESS IS BY KEY.

<u>Set: 2.0</u>					
Doors: 1-100.2, 1-132, 1-134					
1 Pivot Set	147 BLACK	622	RF		
1 Pivot	EM19 QC-12 BLACK	622	RF		
1 Exit Device	43 55 56 8804 LC	US20D	SA		
2 Cylinder	DG1 63 42/ 34 BLACK	US20D	SA		
1 Pull	RM3301-72 (or 96' if reqd) MP BLACK	315	RO		
1 Concealed Closer	91N (PH as required) BLACK	693	RF		
1 Door Stop	467	Black	RO		
1 Threshold	273x3AFG MSES10SS		PE		
1 Gasketing	By Door Manufacturer		00		
1 Sweep	307BPC BLACK POWDER COAT		PE		
1 ElectroLynx Harness	QC-C1500P		MK		
1 eLynx Door Harness	QC-C*** (Length / Type as Required)		MK		
1 Position Switch	DPS-M-BK By Security Vendor		SU		
1 Power Supply	BPS (size & type as required)		SU		

Notes: CARD READER BY SECURITY VENDOR. PRESENTING AUTHORIZED CREDENTIAL TO CARD READER WILL UNLOCK EXIT DEVICE ALLOWING ACCESS. EGRESS IS BY EXIT DEVICE. EMERGENCY ACCESS BY KEY.
OPENING OF DOOR WILL ACIVATE ALARM (CHIME) AT NURSES DESK.

		Set:

	<u> </u>		
Doors: 1-108, 1-114			
1 Continuous Hinge	BLFM_HD1	BLACK	PE
1 Storeroom Lock	DG164 SG 28 10G04 LP BLACK	US20D	SA
1 Concealed Closer	91N (PH as required) BLACK	693	RF
1 Door Stop	467	Black	RO
1 Threshold	2009APK MSES10		PE
1 Gasketing	By Door Manufacturer		00
1 Rain Guard	346C		PE
1 Sweep	307APK		PE
1 Position Switch	DPS-M-BK By Security Vendor		SU
1 Latch Protector	320CL	US32D	RO
	<u>Set: 3.1</u>		
Doors: A-100			
1 Continuous Hinge	BLFM HD1	BLACK	PE

1 Continuous Hinge	BLFM_HD1	BLACK	PE
1 Institutional Lock	DG163 SG 28 10G17 LP	US26D	SA
1 Concealed Closer	91N (PH as required) BLACK	693	RF
1 Door Stop	467	Black	RO
1 Threshold	2009APK MSES10		PE
1 Gasketing	By Door Manufacturer		00
1 Rain Guard	346C		PE
1 Sweep	307APK		PE
1 Position Switch	DPS-M-BK By Security Vendor		SU
1 Latch Protector	320CL	US32D	RO
Notes:			

	<b>Set: 4.0</b>		
Doors: 1-134A			
6 Hinge (heavy weight)	T4A3786	US26	MK
2 Exit Device	12 SG NB8710	US32	SA
2 Concealed Closer	91N (PH as required)	689	RF
2 Kick Plate	K1050 10" high 4BE CSK	US32	RO
2 Electromagnetic Holder	998	689	RF
1 Gasketing	S88BL (Head & Jambs) (perforated at 6" as required)		PE

6" as required) S771C

Notes: MAGNETIC HOLD OPEN RELEASED WHEN FIRE ALARM IS ACTIVATED.

1 Astragal

1 Gasketing

	Set: 5.0		
Doors: 1-116, 1-122, 1-122A, 1-12	2.5		
3 Hinge (heavy weight)	T4A3786 NRP	US26	MK
1 Storeroom Lock	DG164 SG 28 10G04 LP	US26	SA
1 Door Closer	CLP7500	689	NO
1 Kick Plate	K1050 10" high 4BE CSK	US32	RO
1 Gasketing	S88BL (Head & Jambs) (perforat	ted at	DE

6" as required)

**Set: 5.1** Doors: 1-109 T4A3786 NRP US26 MK 3 Hinge (heavy weight) 1 Storeroom Lock DG164 SG 28 10G04 LP US26 SA 1 Electric Strike 630 1006 X 2004M X 2005M 1 Door Closer CLP7500 S88BL (Head & Jambs) (perforated at 1 Gasketing 6" as required) QC-C1500P 1 ElectroLynx Harness 1 Power Supply BPS (size & type as required) Notes: CARD READER BY SECURITY VENDOR. PRESENTING AUTHORIZED CREDENTIAL TO CARD READER WILL UNLOCK ELECTRIC STRIKE ALLOWING ACCESS. FREE EGRESS BY LEVER. **Set: 6.0** Doors: 1-101, 1-102, 1-103, 1-104, 1-105, 1-106, 1-110, 1-111, 1-112, 1-113, 1-117, 1-128, 1-129, 1-130,

3 Hinge (heavy weight)	T4A3786	US26	MK
1 Office Lock	DG163 SG 28 10G05 LP	US26	SA
1 Door Closer	7500	689	NO
1 Wall/ Floor Stop	409/ 446 as required	US32	RO
1 Gasketing	S88BL (Head & Jambs) (perforated at 6" as required)		PE

## Doors: 1-115, 1-118, 1-119, 1-123, 1-124, 1-126, 1-127

3 Hinge (heavy weight)	T4A3786	US26	MK
1 Classroom Lock	DG164 SG 10G37 LP	US26	SA
1 Door Closer	7500	689	NO
1 Kick Plate	K1050 10" high 4BE CSK	US32	RO
1 Wall/ Floor Stop	409/446 as required	US32	RO
1 Gasketing	S88BL (Head & Jambs) (perfora 6" as required)	ted at	PE
1 Door Bottom	411ANBL		PE

	<b>Set: 8.0</b>
Doors: 1-120, 1-121	


3 Hinge (heavy weight)	T4A3786	US26	MK
2 Pull	RM3301-60 Mtg-Type 16 BTB	US32	RO
1 Concealed Closer	91N (PH as required)	689	RF
1 Kick Plate	K1050 10" high 4BE CSK	US32	RO
1 Wall/ Floor Stop	409/446 as required	US32	RO
3 Silencer	608		RO



**BILLINGSLEY FACILITY BUILDING 3** 11,100 BILLINGSLEY ROAD WALDORF, MARYLAND 220602




Thomas E Hall & Associates, Inc. 240 Conestoga Road Wayne, Pa 19087 (610) 293-9900 www.teh-architects.com Architecture • Interiors • Planning

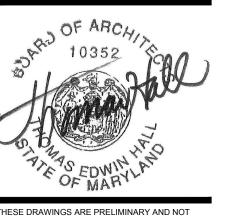

THESE DRAWINGS ARE PRELIMINARY AND NOT OFFICIAL UNTIL SIGNED AND SEALED.
CONTRACTOR SHALL VERIFY DIMENSIONS AND SITE CONDITIONS AND REPORT ANY DISCREPANCIES TO THE ARCHITECT. THE ARCHITECTS IS NOT RESPONSIBLE FOR ANY UNREPORTED DISCREPANCIES.

Consultant

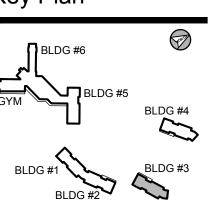

Remodel New Addition New Construction

**Drawing Status** 

## Design Phase Not For Construction

For Pricing For Permit

No.	Date	Description
<u>v</u>	06/03/2016	REVISION #10
<u>1</u>	07/07/2016	REVISION #11
12	07/27/2016	REVISION #12
13	09/16/2016	REVISION #13
14	01/06/2017	REVISION #14
14.1	02/03/2017	ADDENDUM #1
-lab	NIa.	04.40.00

Job No: 6142.00 Drawn By: Checked By: TEH 17 FEB 03

Date: Scale: AS NOTED Drawing Title:

DOOR & HARDWARE SCHEDULES

Sheet No:

**BILLINGSLEY BUILDING 3** 

Copyright © by Thomas E. Hall & Associates, Inc., Wayne, PA 19087, Phone number (610) 293-9900. All rights reserved.