# RECOVERY CENTERS OF AMERICA

# BILLINGSLEY FACILITY BUILDING 4

# 11,100 BILLINGSLEY ROAD WALDORF, MD 20602

STRUCTURAL ENGINEER

#### **OWNER**

**DRAWING LIST** 

SHEET | SHEET LIST

A-0.0 | COVER SHEET

A-1.1 NOT USED

A-0.1 | INFORMATION SHEET

**ARCHITECTURAL DRAWINGS** 

A-1.0 ARCHITECTURAL PLAN BLDG. 4

A-1.3 RCP & CEILING HEIGHTS BLDG. 4

A-3.0 | ARCHITECTURAL SECTIONS

A-3.1 | ARCHITECTURAL SECTIONS

A-4.2 | FOLDING PARTITION DETAILS

A-6.0 | WINDOW SCHEDULES

A-6.1 DOOR SCHEDULES

A-6.2 DOOR HARDWARE

A-0.2 | EGRESS PLANS & CODE COMPLIANCE - BLDG 4

A-1.2 TOILET ROOM PLANS AND ELEVATIONS BUILDING 4

A-2.0 ARCHITECTURAL ELEVATIONS BUILDINGS 4

A-4.0 FLASHING, ROOF & PARTITION DETAILS

A-4.1 WALL FLASHING & SIDING DETAILS

#### **RECOVERY CENTERS OF AMERICA**

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**ARCHITECT** 

## THOMAS E HALL & ASSOCIATES, INC.

240 CONESTOGA ROAD **WAYNE, PA 19087** CONTACT: TOM HALL

thall@teh-architects.com

PHONE: (610) 293-9900

DRAWING LIST - CONT'D.

SHEET | SHEET LIST

H-3.0 HVAC DETAILS

H-5.0 HVAC ENLARGED UNIT PLANS

PLUMBING DRAWINGS

P-1.0 PLUMBING FLOOR PLAN

P-0.0 PLUMBING INFORMATION SHEET

FP-1.0 | FIRE PROTECTION FLOOR PLAN

ELECTRICAL DRAWINGS E-0.0 | ELECTRICAL INFORMATION SHEET

E-2.0 | ELECTRICAL FLOOR PLAN - LIGHTING

E-5.0 | ELECTRICAL ENLARGED UNIT PLANS

E-3.0 | ELECTRICAL SCHEDULES AND DETAILS

E-1.1 | ELECTRICAL ROOF PLAN

P-5.0 | PLUMBING ENLARGED UNIT PLANS

FIRE PROTECTION DRAWINGS

FP-0.0 | FIRE PROTECTION INFORMATION SHEET

E-1.0 | ELECTRICAL FLOOR PLAN - POWER & SIGNAL

MACINTOSH ENGINEERING

LEWES, DE 19958 CONTACT: JAMES BAKER, P.E.

PHONE: (302) 448-2000

• • • • •

32191 NASSAU ROAD - UNIT 2

jbaker@macintosheng.com

### MEP/FIRE PROTECTION ENGINEER

#### BSEG, LLC

4949 LIBERTY LANE - SUITE 115 ALLENTOWN, PA 18106 CONTACT: AHMAD MAHMUD, P.E.

PHONE: (610) 351-8225

### INTERIOR DESIGNER


#### **BALONGUE DESIGN**


707 MATSONFORD ROAD VILLANOVA, PA 19085

CONTACT: BARBARA A. BALONGUE PHONE: 610-525-7593 EXT. 20

barbara@balongue.com

**DRAWING LIST - CONT'D.** DRAWING LIST - CONT'D. **LOCATION MAP** SHEET | SHEET LIST SHEET | SHEET LIST

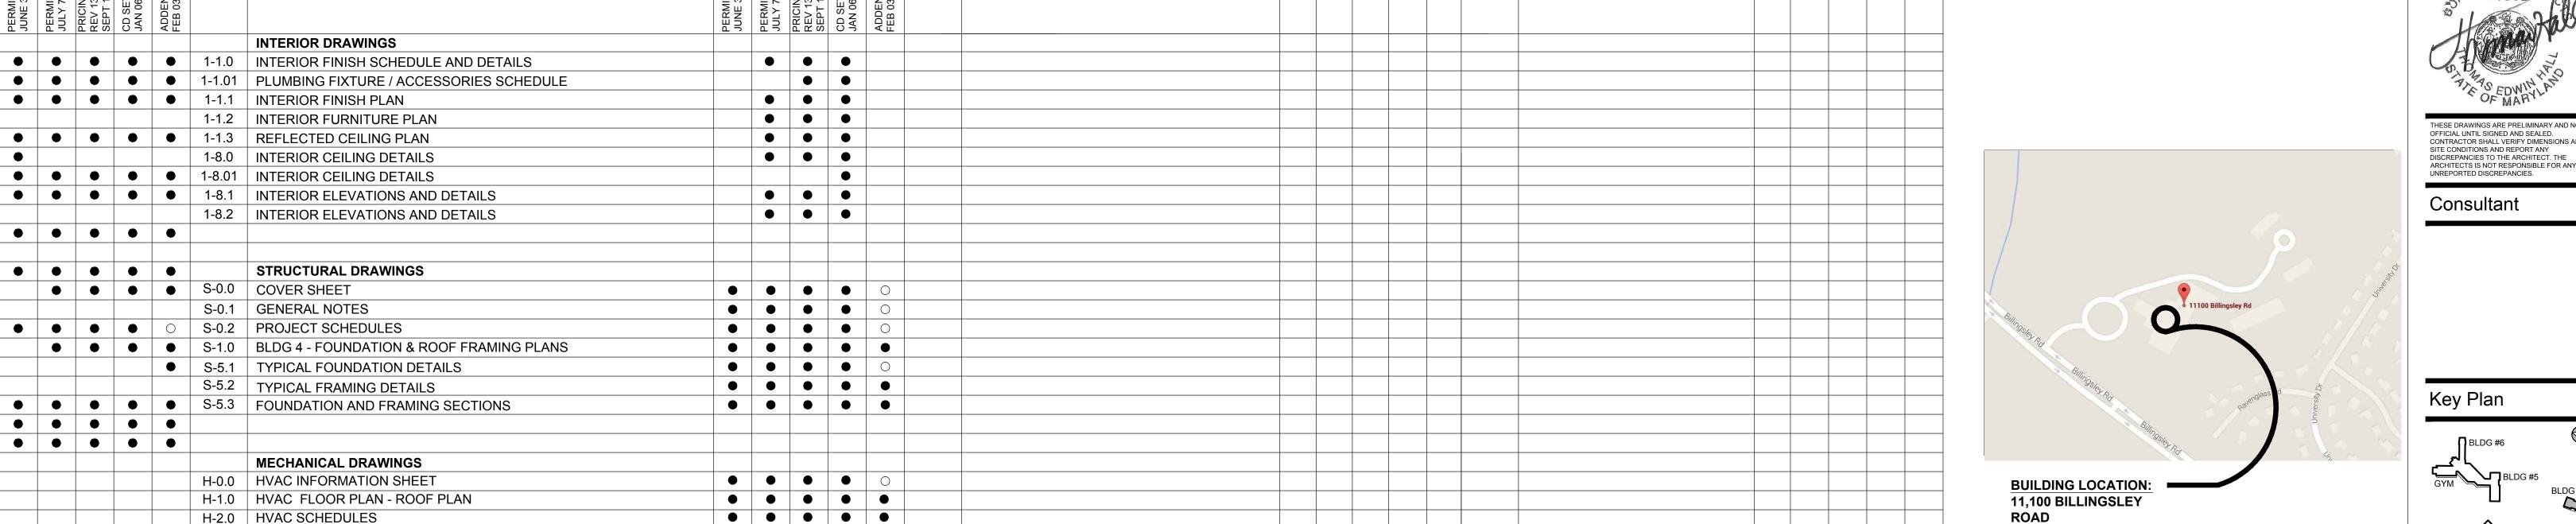

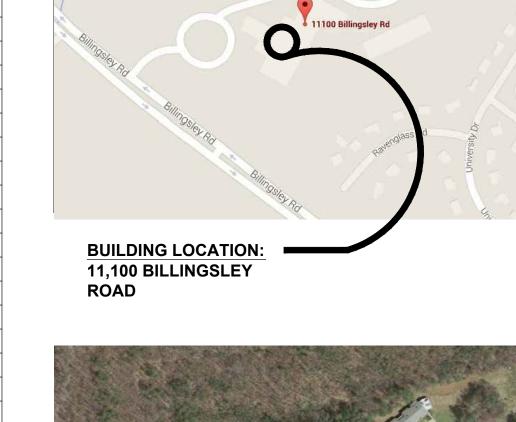



DRAWING ISSUE LEGEND

REVISIONS TO DRAWING / ISSUED DRAWINGS

O NO REVISIONS TO DRAWING

11,100 BILLINGSLEY

Project Type

New Construction

**Drawing Status** 

Not For Construction

Design Phase

For Pricing

For Permit

Revisions

09/16/2016 REVISION #13

Recovery Centers of America

Project

**BILLINGSLEY** 

**FACILITY** 

**BUILDING 4** 

Wayne, Pa 19087

www.teh-architects.com

11,100 BILLINGSLEY

MARYLAND 220602

**ROAD WALDORF** 


01/06/2017 REVISION #14

14.1 02/03/2017 ADDENDUM #1 6142.00 Drawn By:

Checked By: TEH 17 FEB 03 AS NOTED Drawing Title: AS NOTED

COVER SHEET

Sheet No: A-0.0

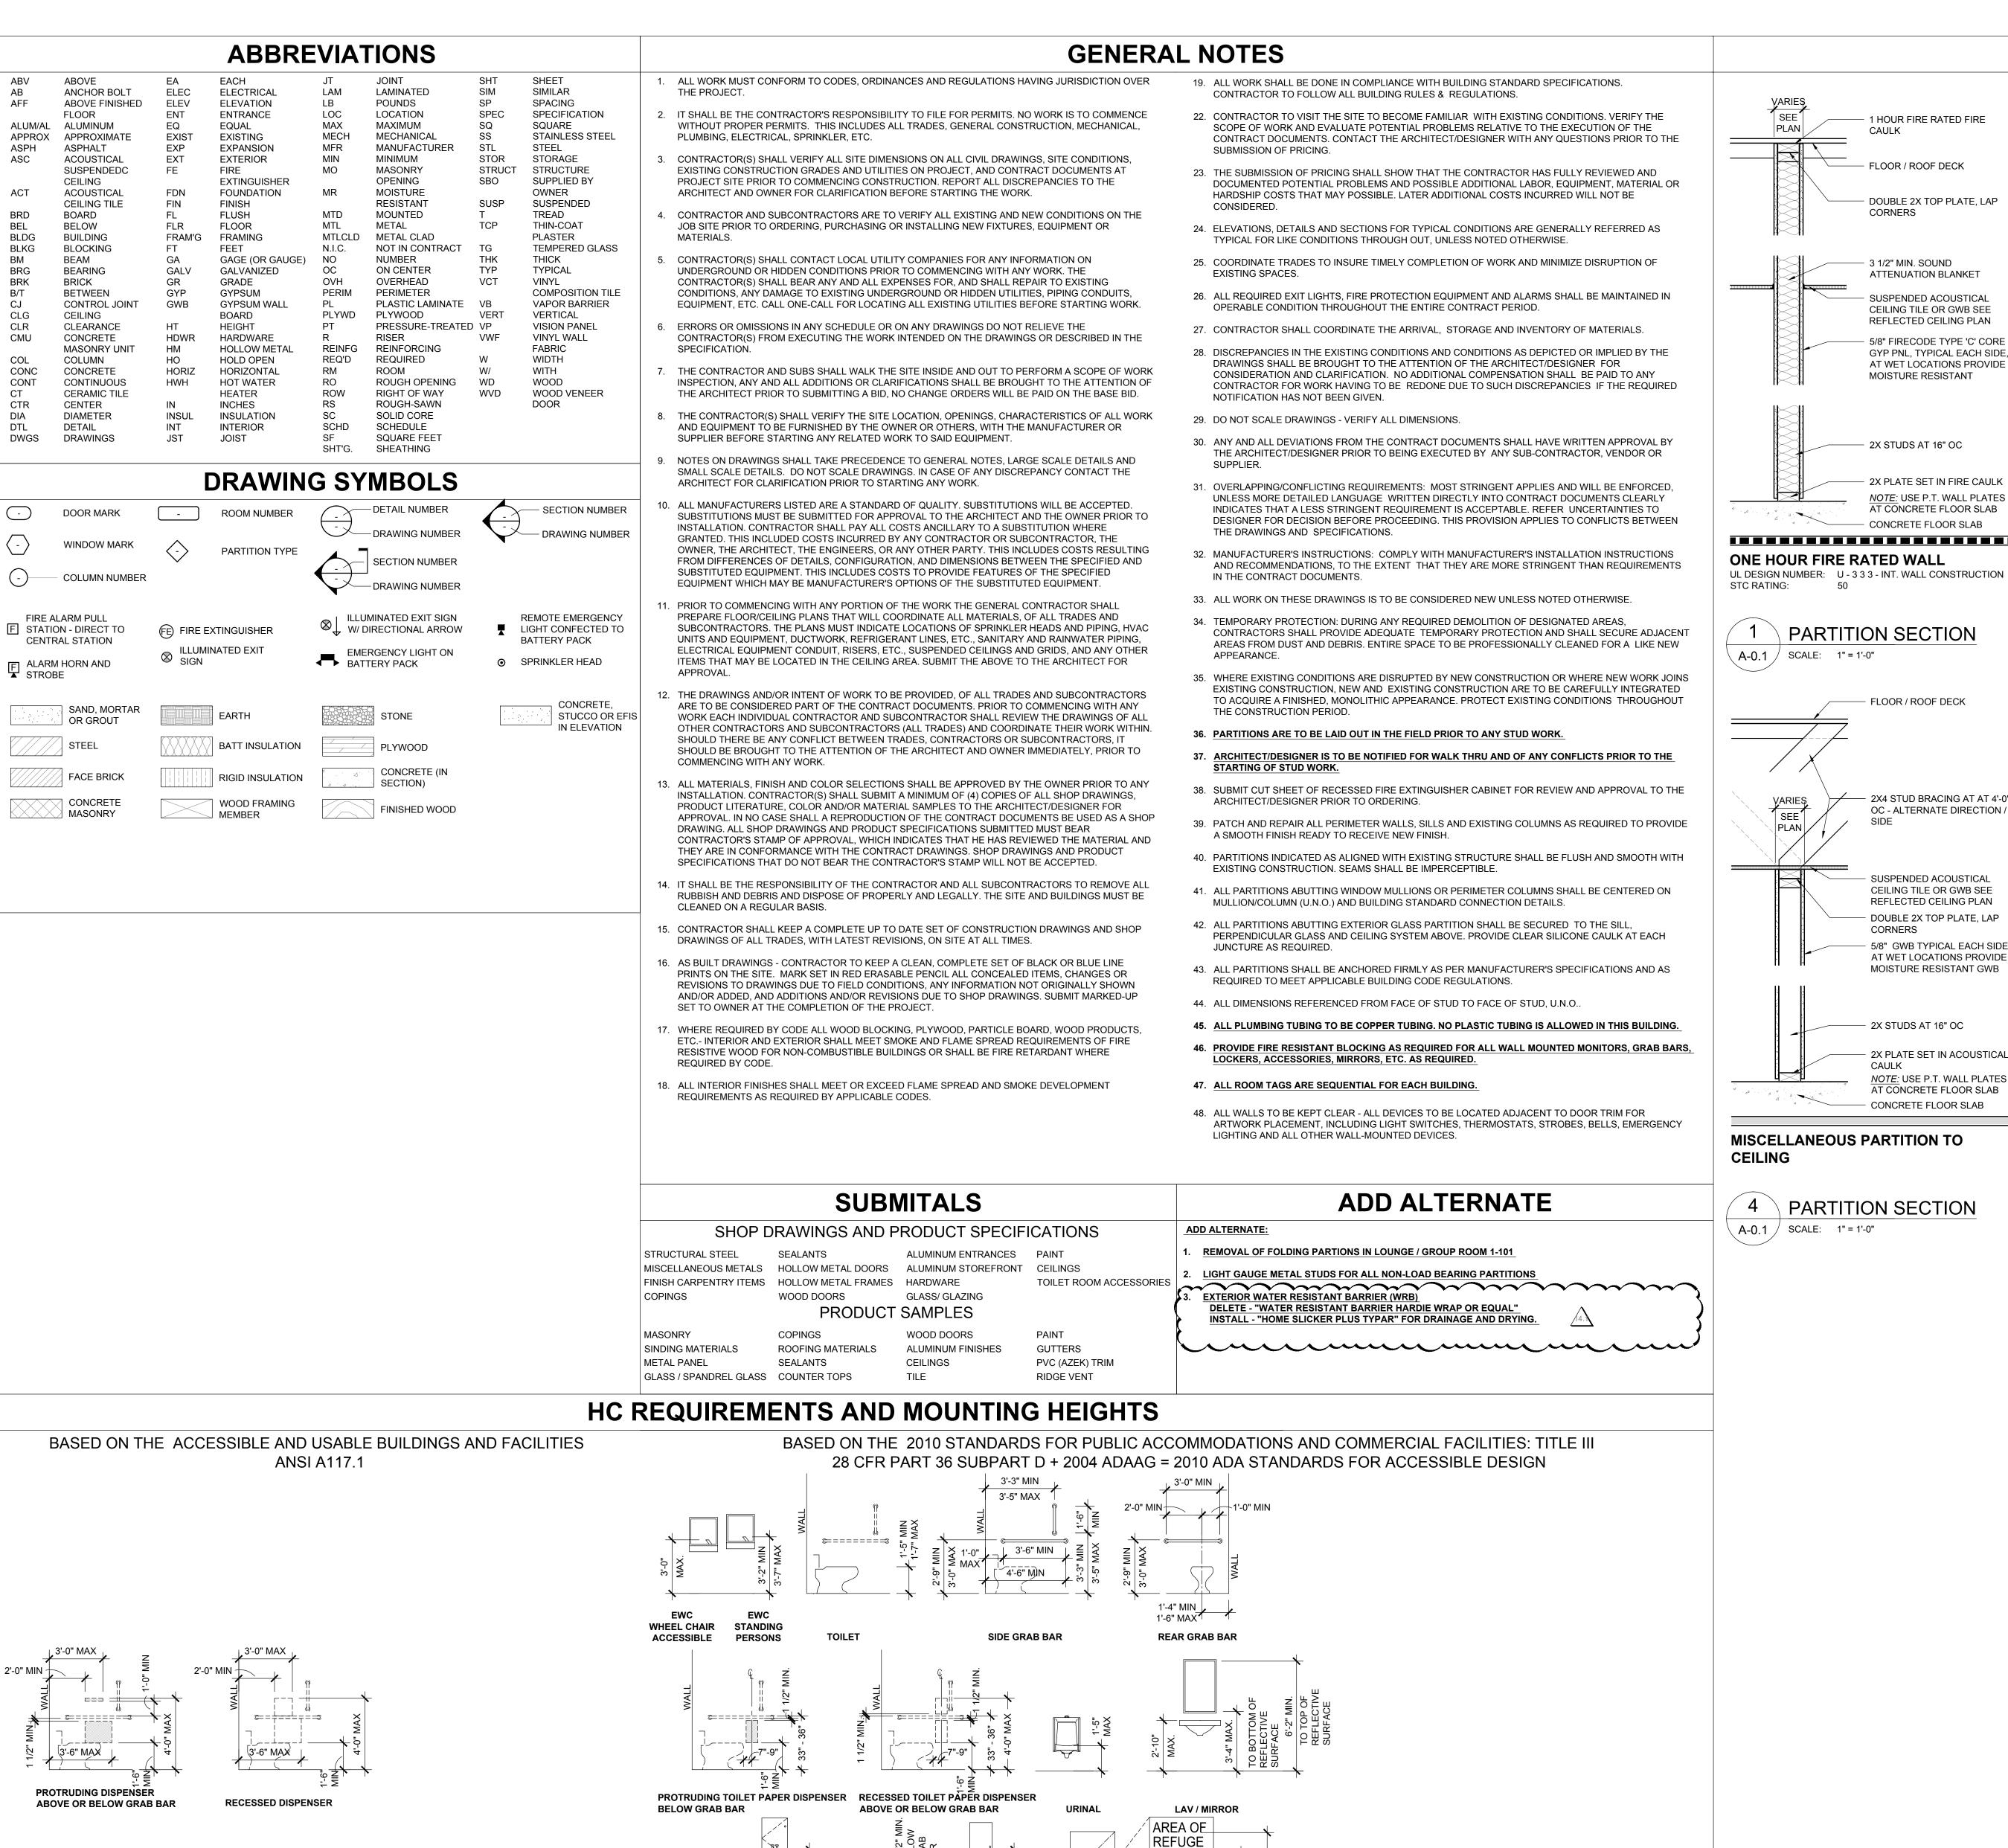

SANITARY

DISPENSER

**PICTOGRAM** 

NAPKIN VENDOR DISPOSAL (HC)

INTERNATIONAL

**ACCESSIBILITY** 

SIGN OF

SANITARY NAPKIN TOWEL DISPENSER/


DISPOSAL

**TACTILE SIGN** 

**LOCATION HEIGHT** 

**TACTILE SIGN** 

**COAT HOOK HEIGHT** TOWEL HOLDER HGT.

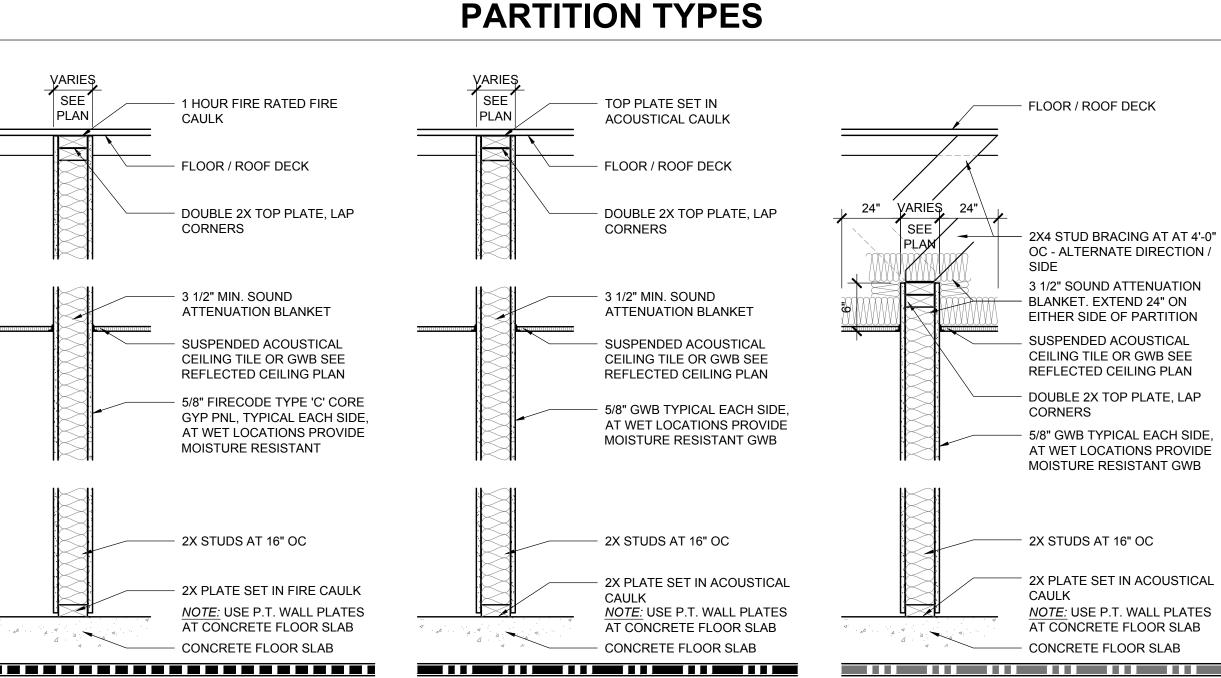

**FULL HEIGHT SOUND PARTITION** 

STC RATING:

A-0.1 / SCALE: 1" = 1'-0"

FLOOR / ROOF DECK

OC - ALTERNATE DIRECTION /

SUSPENDED ACOUSTICAL

CORNERS

CEILING TILE OR GWB SEE

REFLECTED CEILING PLAN

DOUBLE 2X TOP PLATE, LAP

5/8" GWB TYPICAL EACH SIDE

AT WET LOCATIONS PROVIDE

MOISTURE RESISTANT GWB

2X PLATE SET IN ACOUSTICAL

NOTE: USE P.T. WALL PLATES

AT CONCRETE FLOOR SLAB

- CONCRETE FLOOR SLAB

2X STUDS AT 16" OC

PARTITION SECTION PARTITION SECTION A-0.1 SCALE: 1" = 1'-0" A-0.1 / SCALE: 1" = 1'-0" — TS 3.5 x 3.5 x 11GA HEIGHT — TS 3.5 x 3.5 x 11GA HEIGHT TO BE FIELD VERIFIED TO BE FIELD VERIFIE CAULK (INSIDES) -STEEL PLATE -STEEL PLATE 3.5 x 9 x 1/4" 3.5 x 6 1/4 x 1/4" - FLOOR / ROOF -(2) 1/2" Ø HILTI —1/2" Ø HILTI EXPANSION ANCHOR EXPANSION ANCHOR 2X4 TOP PLATE **ELEVATION - MIDDLE ELEVATION - END** 2X6 TOP PLATE ∠—TS 3.5 x 3.5 x 11GA HEIGH —STEEL PLATE 3.5 x 9 x 1/4" - 2X4 STUD BRACING AT AT 4'-0" TS 3.5 x 3.5 x 11GA HEIGHT TO BE FIELD VERIFIED TO BE FIELD VERIFIED 1/2" Ø HILTI EXPANSION - 5 1/2" OR 3 1/2" FOIL FACED (2) 1/2" Ø HILTI EXPANSION ANCHOR BATT INSULATION ANCHOR —STEEL PLATE 3.5 x 6.25 x <sup>2</sup> SUSPENDED ACCOUSTICAL PLAN VIEW - MIDDLE PLAN VIEW - END CEILING TILE OR GWB SEE -WALL CAPS & TRIMS, SEE REFLECTED CEILING PLAN INTERIOR DESIGN DRAWINGS 5/8" GWB TYPICAL CONTINUOUS DBL 2x AT WET LOCATIONS PROVIDE WOOD TOP PLATE MOISTURE RESISTANT -5/8" G.W.B. TYPICAL EACH SIDE PROVIDE MOISTURE RESISTAN G.W.B. AT WET LOCATIONS 5/8" CDX RATED EXTERIOR PLYWOOD SHEATHING 2x WOOD STUDS AT 16" o.c. WITH 3.5" x 3.5" MTL COLUMN - BUILDING WRAP "WRB" WITH 1/4" BASE PLATE EXTERIOR FINISH **BOLTED TO FLOOR LOCATED** SEE ELEVATIONS END & MIDPOINT OF WALL 2X4 OR 2X6 STUDS AT 16" OC (SEE DETAIL ABOVE). SEE PLAN -CONTINUOUS P.T. 2X PLATE SE IN CONSTRUCTION ADHESIVE SILL FLASHING & TERMITE SHIELD -CONCRETE FLOOR SLAB, SEE 2X4 OR 2X6 PLATE STRUCTURAL DRAWINGS SET IN CAULK EXST. CONC. FLOOR SLAB **EXTERIOR WALL** STANDARD LOW PARTITION 5 PARTITION SECTION 6 PARTITION SECTION

> REFER TO FLOOR PLANS FOR 2X4 AND 2X6 WALL LOCATIONS, USE THE APPROPRIATE WALL TYPE AS INDICATED.

A-0.1 / SCALE: 1" = 1'-0"

**CEILING HEIGHT SOUND PARTITION** 

STC RATING:

### **PARTITION NOTES**


- SEE FINISH SCHEDULE AND DETAILS FOR PARTITION FINISHES, TRIM, BASE TYPE, ETC.
- 2. ALL PARTITIONS ARE SUBJECT TO LIMITING HEIGHT DETERMINED BY STUD SIZE, STUD GAUGE, AND/OR LATERAL BRACING.
- 3. FIRE RATED PARTITIONS TO RUN FROM FINISH FLOOR TO UNDERSIDE OF ROOF OR FLOOR DECK. SEAL ALL VOIDS AND/OR PENETRATIONS WITH CLASS I MATERIAL AS REQUIRED BY FIRE RATING UNDERWRITER. FIRE RATED PARTITIONS SHALL RUN OVER DOORS AND/OR BORROWED LIGHT OPENINGS.
- 4. DOORS WITHIN ALL RATED PARTITIONS ARE TO BE RATED IN COMPLIANCE TO WALL
- PROVIDE ACOUSTICAL SEALANT AT ALL PARTITIONS WHICH CONTAIN SOUND ATTENUATION BLANKETS, SET BOTTOM PLATE IN TWO CONTINUOUS BEADS OF SEALANT.



Project **BILLINGSLEY FACILITY BUILDING 4** 11,100 BILLINGSLEY ROAD WALDORF

MARYLAND 220602

Thomas E Hall & Associates, Inc. 240 Conestoga Road Wayne, Pa 19087 (610) 293-9900 www.teh-architects.com Architecture • Interiors • Planning

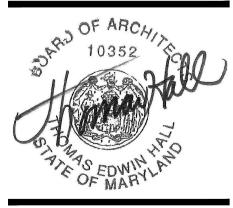

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Consultant

Key Plan

Project Type

Alteration

Remodel New Addition

New Construction

**Drawing Status** 

Design Phase Not For Construction

For Pricing For Permit Revision

For Construction

Revisions

No. Date 06/03/2016 REVISION #10 1 07/07/2016 REVISION #11 7 07/27/2016 REVISION #12 13 09/16/2016 REVISION #13 01/06/2017 REVISION #14 **√**<sub>4</sub> \ 02/03/2017 | ADDENDUM #1

Job No: 6142.00 Drawn By: Checked By: TEH 17 FEB 03 AS NOTED Scale:

INFORMATION

Drawing Title:

EGRESS PLAN - BUILDING FOUR A-0.2 SCALE: 1/16" = 1'-0"

CODES

ADOPTED CODES FOR USE IN THE STATE OF MARYLAND CHARLES COUNTY - EFFECTIVE 3 AUG 2015

2015 INTERNATIONAL BUILDING CODE CHARLES COUNTY BUILDING CODE (COMAR 05.02.02) MARYLAND ACCESSIBLE CODE GUIDELINES FOR BUILDINGS AND FACILITIES - 2012 2010 ADA STANDARDS FOR ACCESSIBLE DESIGN

2015 NFPA 101 LIFE SAFETY CODE 2015 NFPA 220 STANDARD ON TYPES OF BUILDING CONSTRUCTION 2015 INTERNATIONAL ENERGY CODE

2015 INTERNATIONAL EXISTING BUILDING CODE 2015 INTERNATIONAL MECHANICAL CODE 2015 INTERNATIONAL PLUMBING CODE 2015 INTERNATIONAL FUEL GAS CODE 2015 INTERNATIONAL FIRE CODE 2013 NFPA 13 - SPRINKLER SYSTEMS 2014 NATIONAL ELECTRIC CODE NFPA 70

2013 NFPA 72 - NATIONAL FIRE ALARM AND SIGNALING CODE 2 APPLICABLE CODES

A-0.2 SCALE: NO SCALE

CODE OFFICALS A-0.2 SCALE: NO SCALE

CODE OFFICIAL CONTACT

MARYLAND CODES ADMINISTRATION

100 COMMUNITY PLACE

landon@mdhousing.org

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STATE FIRE MARSHALL

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(410) 514-7444

CROWNSVILLE, MD 21032

1201 REISTERSTWON ROAD

DIRECTOR OF CODE ADMINISTRATION

BUILDING 4 - FIRST FLOOR 6,416 SF / 30 OCC IN-PATIENT SLEEPING AREAS 9,180 SF SLEEPING ROOM AREA 5,294 SF (10 RM -2 OCC) 20 OCC FIXTURE REQUIRED PROVIDED PATIENT ROOMS 1 B.RM / 8 OCC 10 ROOMS - 2 OCC / RM SLEEPING AREA STAFF 1,122 SF AT 120 SF/OCC 10 OCC **FIXTURE** REQUIRED PROVIDED TOILET 10 OCC / 1 WC PER 25 OCC 1 WC LAVATORIES 10 OCC / 1 LAV PER 35 OCC DRINKING FOUNTAIN 1 EWC 1 EWC SERVICE SINK 1 SS 1 SS \* SERVERY WITH SINK PROVIDED

DESIGN OCCUPANT LOAD AND 4 REQUIRED PLUMBING FIXTURES A-0.2 SCALE: NO SCALE

#### **BUILDING #4**

SECTION 1107.5 GROUP I-1 ACCESSIBLE UNITS

THE SLEEPING UNITS (SU) ARE DESIGNED AS FOLLOWS:

- "FA" SLEEPING UNITS CONDITION 1 4% OF THE SLEEPING UNITS WITH TOILETS
- "FA" SLEEPING UNITS CONDITION 2 10% OF THE SLEEPING UNITS WITH TOILETS
- TYPE "B" SLEEPING UNITS ALL REMAINING TO BE SLEEPING UNITS WITH TOILETS


4% "FA" - CONDITION 1 10 SU x 4%= 0.4 1 REQ'D 1 PROV'D 10% "FA" - CONDITION 2 SU x 10%= 0 REQ'D 0 PROV'D 9 PROV'D 9 PROV'D TYPE "B" - ALL OTHERS TOTAL - SLEEPING UNITS 10 TOTAL

SLEEPING UNIT CALCULATIONS A-0.2 SCALE: N/A

| Code Chapter                                      | NFPA 101 - 2015 Required   | IBC 2015 Required   | Provided   | Comment  |
|---|--|---|--|--|
| Use Group/Ocupancy                                | Chapter 32 - New Residential Board and Care Occupancies - Large Facility                                   | I-1 (308.3) In-Patient Areas Condition 1  | I-1, Condition 1 Residential Board & Care - Large Facility | Buildings used for Drug and Alcohol Treatment Centers, Occupants are capable of responding to emergency situation with-out physical assistance from staff. |
| Special requirements based on use & occupancy I-1 |  | Separation Walls - between sleeping units and corridor walls are to be fire partitions in accordance to (709) | Yes  |  |
|   |  | Horrizontal separation in accordance with (712)   |  |  |
| General building heights and areas                |  |   |  |  |
| Existing / New Building Area and Height           |  |   |  |  |
| Building 4 - First Floor                          | V (000) / 1 St   | 15,750 SF / 3 St  | 6,416 SF - One Story                                       | I - 1 Use, V-B Construction  |
| Total Building Square Footage                     |  | [13,500 + (4,500 x 0.5)] x 1 = 15,750 SF  | 6,416 SF   |  |
| Incidental accessory occupancy                    |  | See (Table 509)   | Fire Rated Per   |  |
| Construction Type                                 | V (000) (Table 32.3.1.3)   | 5 B (Table 506.2)   | 5 B (Table 506.2)  |  |
| Primary Structure                                 | 0 Hr   | 0 Hr  | 0 Hr   |  |
| Bearing walls interior or exterior                | 0 Hr   | 0 Hr  | 0 Hr   |  |
| Non bearing walls exterior                        | 0 Hr   | 0 Hr (Table 602), >10 feet  | 0 Hr   |  |
| Non bearing walls and partitons interior          | 0 Hr   | 0 Hr  | 0 Hr   |  |
| Floor Construction and Secondary Members          | 0 Hr   | 0 Hr  | 0 Hr   |  |
| Roof Construction and Secondary Members           | 0 Hr   | 0 Hr  | 0 Hr   |  |
| Fire Partitions / Barriers                        | 1 Hr   | 1 hr 709.3  | 1 Hr   | I-1 In-Patient Areas   |
| Flame Spread Index                                |  | <25   |  |  |
| Fire and smoke protection                         |  |   |  |  |
| Fire Door - 1 hr Fire Rated Wall                  | 3/4 Hr   | 1 Hr  | 1 Hr   |  |
| Fire Door - 1 hr Fire Rated Corridor Wall         | 1/3 Hr   | 1/3 Hr  | 1/3 Hr   | Corridor Walls   |
| Interior finishes                                 |  |   |  |  |
| Exit Enclosures and Passage Ways                  | Class A / Floor - Class II   | Class B (Table 803.11)  | Class A  |  |
| Corridors   | Class B / Floor - Class I or II  | Class C (Table 803.11)  | Class B  |  |
| Rooms and Enclosed spaces                         | Class B / Floor - Class I or II  | Class C (Table 803.11)  | Class B  |  |
| Contents and Furnishings                          | Section 10.3 (10.3.1 thru 10.3.9.2)  |   | Provided per NFPA (10.3)                                   |  |
| Fire protection systems                           |  |   |  |  |
| Sprinkler System                                  | Required (32.2.3.5.3) - NFPA 13  | Required (903.2.6) - NFPA 13R   | Provide per NFPA 13  |  |
| Portable fire extinguishers                       | Required (9.9)   | Required (906.1)  | Provide per NFPA 101 Sec 9.9                               |  |
| Fire Alarm & Detection system                     | Required (9.6) & (32.3.3.4)  | Required (907.2.6.1 & 907.2.6.2)  | Provide per NFPA 101 Sec 9.6 & 32.3.3.4                    |  |
| Means of egress                                   |  |   |  |  |
| Design Occupant Load - Building 4 First Floor     | 30 Occupants   | 30 Occupants  | See Occupant Tables  |  |
| Egress Width - Building 4 First Floor             | Other Componets: 30 x .20" = 6"  | Other Componets: 30 x .20" = 6"   | 170" Provided  |  |
| Corridor wall rating                              | 1/2 Hr (32.3.3.6.3)  | 1/2 Hr (711.2.4.3 Exception 1)  | 1/2 Hr   |  |
| Maximum Exit Travel Distance                      | 200', Sprinklers Provided  | 250', Sprinklers Provided (Table 1017.2)  | <200'  |  |
| Means of egress illumination                      | 1 FC Min Typical / 10 FC Stairs  | Required 24 hrs./ day. 1 FC Min   | Provided per NFPA (7.8.1.3)                                | Illumination required during power failure   |
| Special locking arrangements                      | Permitted (7.2.1.6.1.1)  | Permitted (1010.1.9.7(1) thru (8)   | Provide per NFPA (7.2.1.6.1.1)                             | Delayed-Egress Locking Systems   |
| Exit signs  | Located / Lighted per (7.10)   | Located per section (1013)  |  |  |
| Exit through intervenening spaces                 | Allowed through accessory spaces, but must provide a discernable path of egress travel through that space. | Allowed through accessory spaces, but must provide a discernable path of egress travel through that space.    |  |  |

5 \ 2015 NFPA AND IBC 2015 CODE REQUIREMENTS - BUILDING 4 A-0.2 SCALE: NO SCALE


- SPRINKLER SHOP DRAWINGS AND FIRE ALARM SHOP DRAWINGS TO BE SUBMITTED TO THE FIRE MARSHALL - FIRE ALARM DEVICES IN SLEEPING AREA SHALL PROVIDE LOW FREQUENCY SIGNAL IN ACCORDANCE WITH NFPA 72

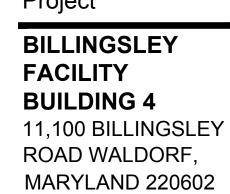

Recovery Centers of America



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Consultant

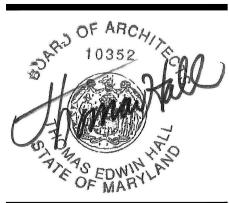BLDG #2

Project Type Alteration

Remodel New Addition

New Construction **Drawing Status** 

Design Phase Not For Construction

For Pricing For Permit

Revision For Construction

Revisions

No. Date

06/03/2016 REVISION #10 07/07/2016 REVISION #11 07/27/2016 REVISION #12 09/16/2016 REVISION #13 01/06/2017 REVISION #14

02/03/2017 ADDENDUM #1 Job No: 6142.00 Drawn By:

Checked By: TEH Date: 17 FEB 03 Scale: AS NOTED Drawing Title: AS NOTED

EGRESS PLANS & CODE COMPLIANCE Sheet No:

A-0.2

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BILLINGSLEY BUILDING 4


R12 PARAPET WALL WITH CAP FLASHING TYPICAL

FRAMING MEMBERS, TYPICAL


ATTIC DRAFTSTOPPING LOCATION - FULL HEIGHT AND WIDTH - ALIGN WITH SMOKE COMPARTMENT WALLS AS INDICATED, DRAFTSTOPPING


TO BE 5/8" GWB OR 1/2" PLYWOOD PER NFPA 101 SECTION 8.6.11

GC TO COORDINATE ACCESS DOOR LOCATION WITH EXISTING ROOF TRUSS

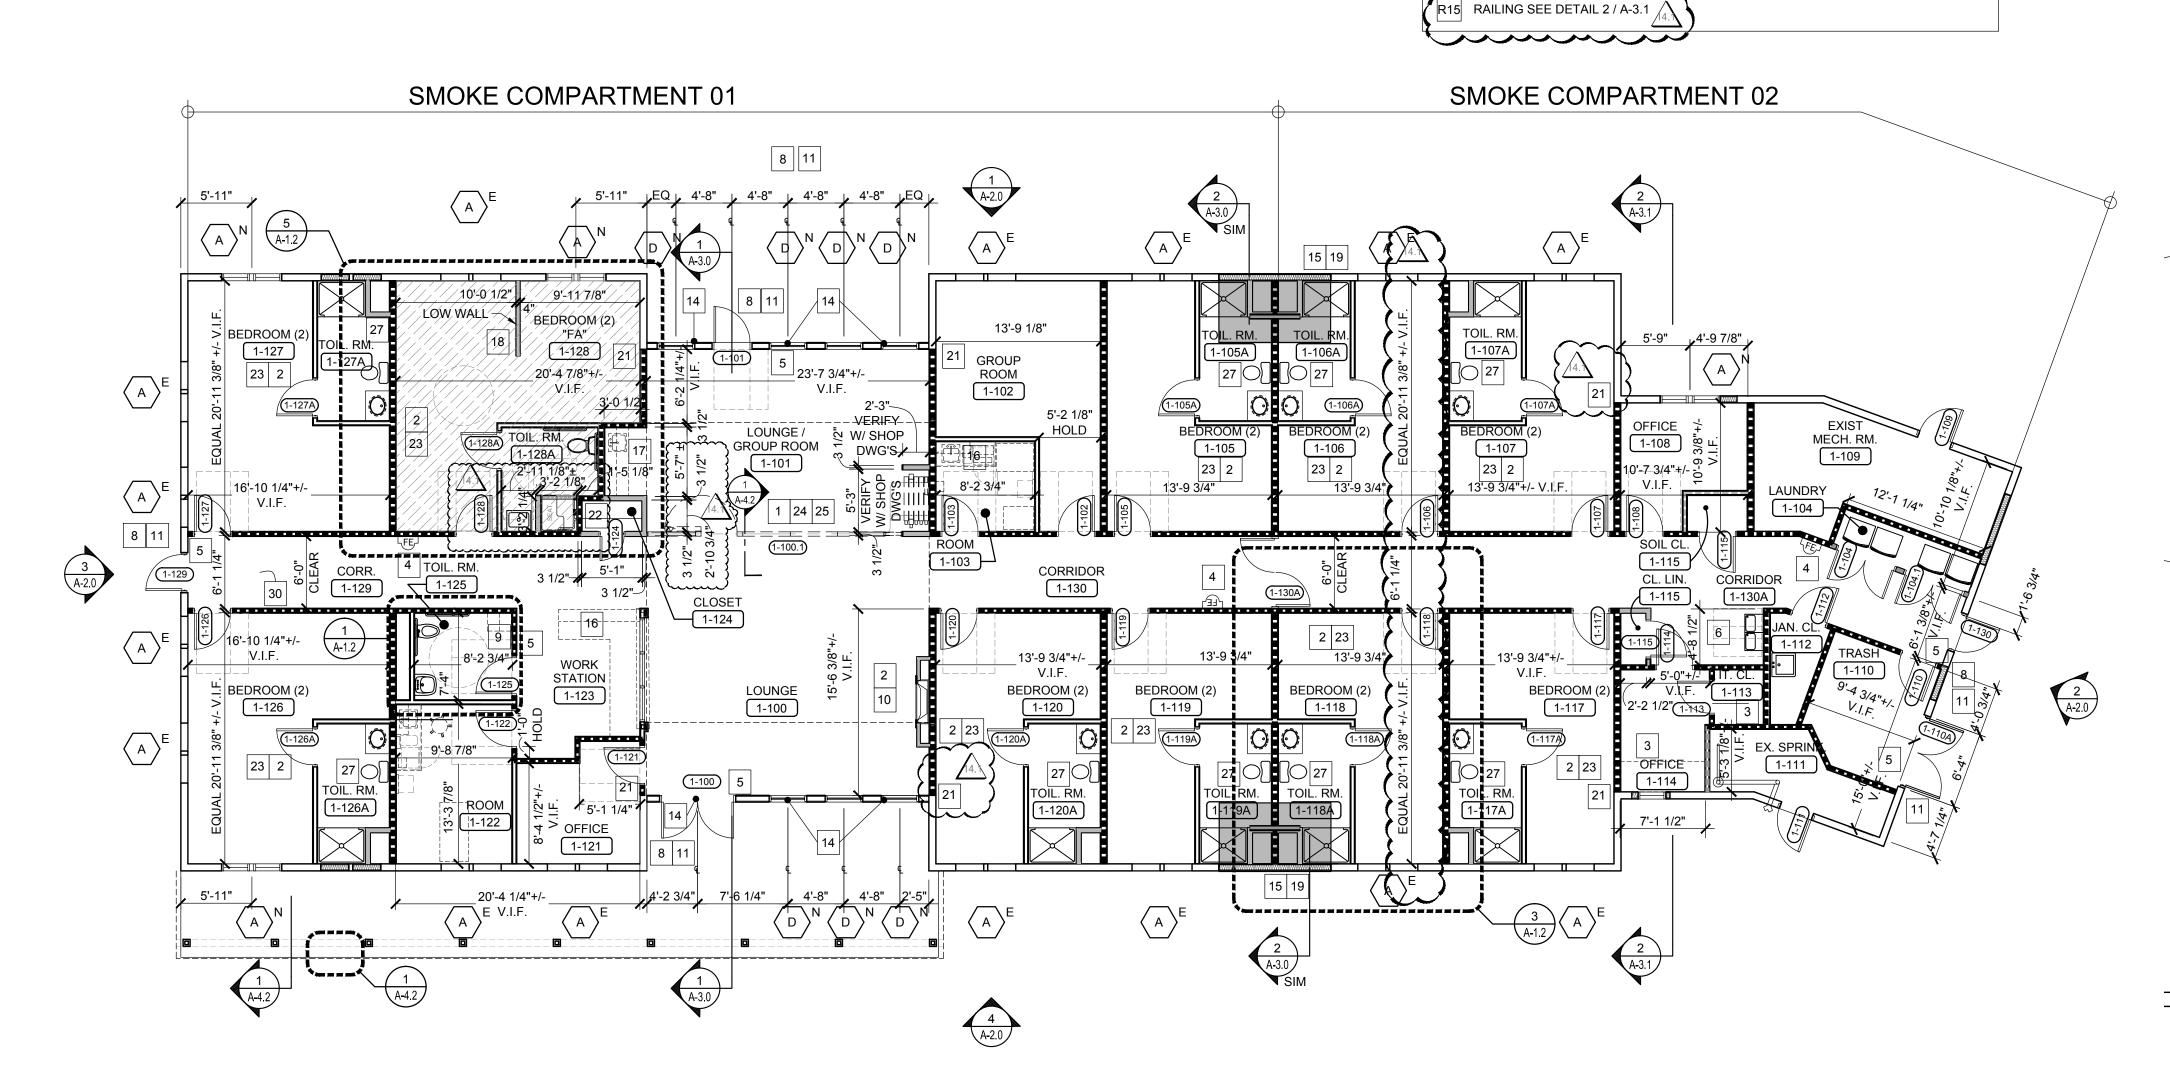

FLOOR PLAN BUILDING NO. 4 A-1.0 / SCALE: 1/8" = 1'-0"

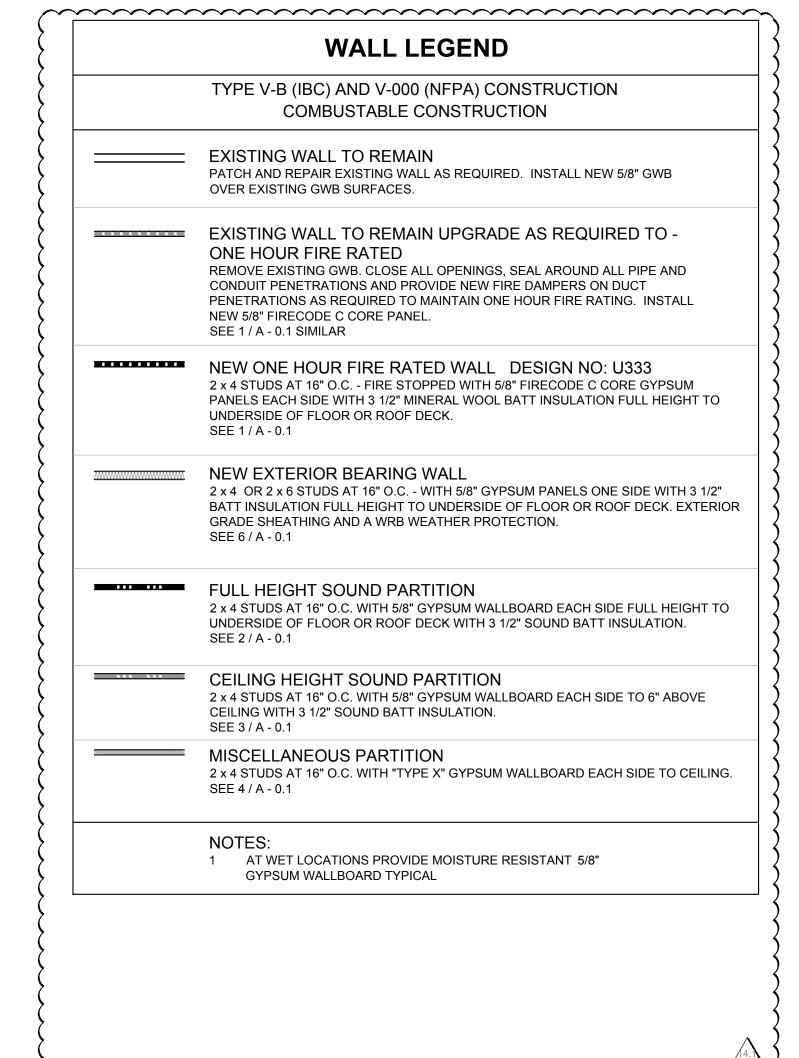

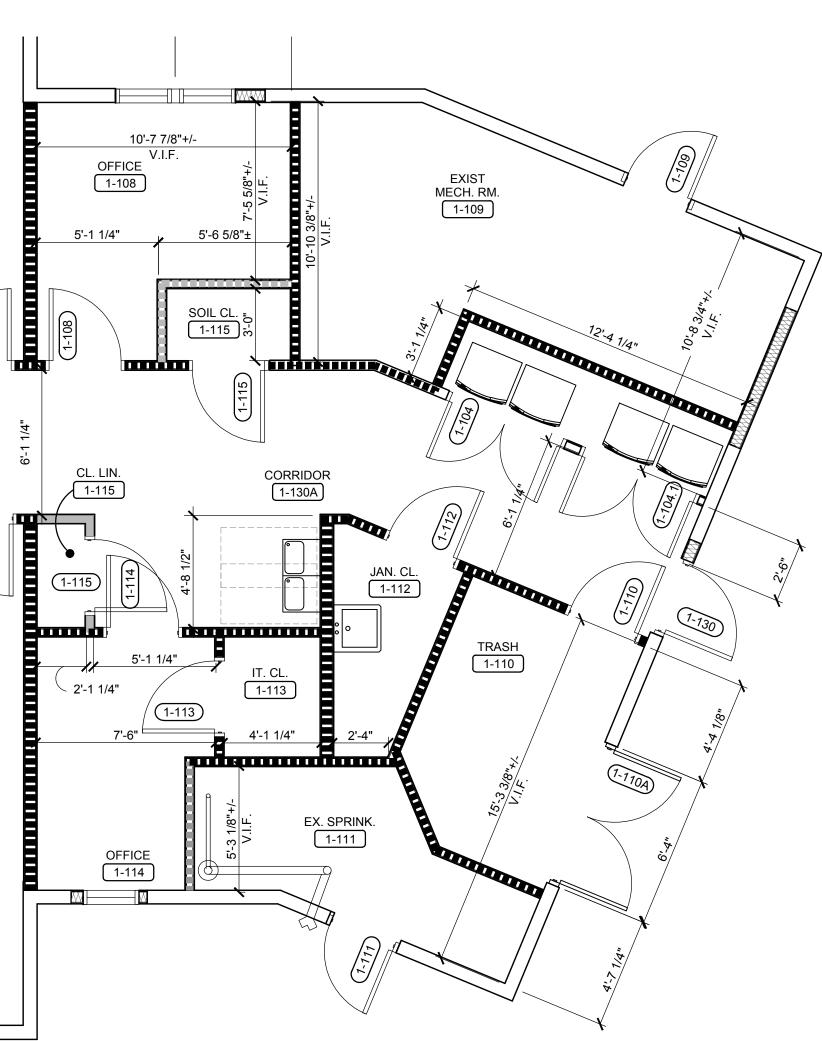

ARCHITECTURAL KEYNOTES

- GC TO COORDINATE ALL STRUCTURAL AND FINISHED DIMENSIONS WITH THE MOVEABLE PARTITION MANUFACTURER PRIOR TO STUD INSTALLATION FOR ACCURATE WALL AND GWB CEILING LOCATION AND SIZE. HOLD GWB SOFFIT FLUSH IF POSSIBLE
- PROVIDE PLYWOOD BLOCKING AS REQUIRED TO MOUNT LCD MONITORS. THE SIZE OF THE BACKER BOARD TO MATCH THE SIZE OF THE LCD SCREEN. INSTALL BEHIND GWB. HEIGHT AND FINAL LOCATION TO BE COORDINATED WITH BUILDING OWNER REPRESENTATIVE PRIOR TO INSTALLATION. BUILDING OWNER TO COORDINATE TO LCD SCREEN SPECIFICATIONS. COORDINATE WITH THE INTERIORS FURNITURE, POWER AND DATA PLANS
- PROVIDE 4' X 8' PLYWOOD AS REQUIRED FOR BUILDING OWNER SERVER ROOM EQUIPMENT. FINISH AS REQUIRED TO MATCH THE FINISH ON WHICH IT APPEARS. HEIGHT AND FINAL LOCATION TO BE COORDINATED WITH BUILDING OWNER
- PROVIDE FULLY-RECESSED FIRE EXTINGUISHER CABINET(FIRE-RATED WHERE REQUIRED) FOR A 10# ABC FIRE EXTINGUISHER EXTINGUISHER AS MANUFACTURED BY: ACTIVAR, INC., SERIES: EMBASSY-TRIMLESS, #5614W10, FULLY-RECESSED . STYLE: VERTICAL DUO. RECESSED HANDLE WITH SAF-T-LOK. COLOR: FACTORY PAINTED TO MATCH WALL ON WHICH IT APPEARS, APPROX. ROUGH OPENING SIZE: 25" H X 5 7/8" D X 11 1/2"W - INCREASE WALL THICKNESS AS REQUIRED, MOUNT AS REQUIRED TO MEET CODE REQUIREMENTS. INSTALL AS RECOMMENDED BY THE MANUFACTURER OR APPROVED EQUAL
- INDICATES CODE COMPLIANT/ADAAG COMPLIANT TACTILE SIGNAGE TO BE PROVIDED BY THE BUILDING OWNER SIGNAGE VENDOR
- PROVIDE WALL MOUNTED CHILLED CODE COMPLIANT HIGH/LOW DRINKING FOUNTAIN WITHOUT FILLER OPTION WITH REMOTE CHILLER. FINISH: TBD. INSTALL AS REQUIRED TO BE VANDAL RESISTANT AND BARRIER FREE.
- NUMBER NOT USED
- 8 SEE CIVIL DRAWINGS FOR EXTERIOR IMPROVEMENTS
- NUMBER NOT USED
- INDICATES ELECTRIC FIREPLACE. SEE ID DRAWINGS FOR POWER & MOUNTING
- REWORK EXISTING EXTERIOR AND GRADING AS REQUIRED TO PROVIDE THE ENTRANCE AS REQUIRED BY NEW LAYOUT
- 12 NUMBER NOT USED
- NUMBER NOT USED
- REMOVE EXISTING COLUMN AND REWORK STRUCTURE AS REQUIRED BY NEW LAYOUT. SEE STRUCTURAL DRAWINGS
- HATCHED AREA: SEE STRUCTURAL DRAWINGS FOR NEW FOOTING, ∫ FOUNDATION, SLAB, WALL, AND ROOF FRAMING AS REQUIRED BY NEW LAYOUT
- MILLWORK, PLUMBING AND EQUIPMENT DETAILS, SEE INTERIOR DESIGN 16 DRAWINGS
- SERVERY, PLUMBING AND EQUIPMENT DETAILS, SEE INTERIOR DESIGN DRAWINGS
- LOW WALL SEE 5/A-0.1 PARTITION TYPE STANDARD LOW WALL HEIGHT TO BE 7'-0" AFF
- HATCHED AREA: SEE STRUCTURAL DRAWINGS FOR NEW FOOTING, FOUNDATION, SLAB, AND WALL INFILL BELOW EXISTING LOW SLOPE ROOF
- 20 NUMBER NOT USED
- 21 ALIGN FOR A SMOOTH TRANSITION AS REQUIRED
- PROVIDE MELAMINE SHELVING AND COAT ROD OR (5) FIVE ADJUSTABLE MELAMINE SHELVING WITH HEAVY DUTY HARDWARE AS REQ'D
- PROVIDE SHELF MOUNTED PERSONAL SAFE FOR EACH PATIENT IN THEIR
- RESPECTIVE BEDROOM CLOSET OR WARDROBE UNIT 24 PROVIDE A DOOR IN THE FOLDING PARTITION PANEL
- HOLD PARTITION WALLS TO A MINIMUM DEPTH AND LENGTH TO CAPTURE THE
- STACKING PANELS. COORDINATE WITH MOVEABLE PARTITION VENDOR PROVIDE NEW WINDOWS. SEE EXTERIOR AND INTERIOR ELEVATIONS.
- PROVIDE BLOCKING FOR FUTURE GRAB BARS IN TYPE "B" UNITS AND ROLL IN
- SHOWER UNITS FOR FUTURE SEAT. SEE ELEVATIONS FOR REFERENCE. 28 NUMBER NOT USED
- 29 NUMBMER NOT USED
- 30"x36" ATTIC ACCESS PANEL AS REQUIRED
- ARCHITECTURAL GENERAL NOTES
- . GC TO REMOVE EXISTING WALL AND ROOF SHEATHING AS REQUIRED. GC TO VERIFY THE CONDITION OF THE EXISTING FRAMING IS FREE OF; MOLD, DRY ROT, WATER DAMAGE, INSECT DAMAGE, STRUCTURAL DAMAGE, ETC. AND IS SUITABLE FOR INSTALLATION OF NEW WALL AND ROOF SHEATHING PRIOR TO INSTALLATION OF ANY NEW EXTERIOR SHEATHING, TYPICAL
- . INSTALL NEW ROOFING SYSTEMS AND ALL OF THEIR COMPONENTS PER THE ROOFING MANUFACTURERS SPECIFICATIONS REQUIREMENTS FOR INSTALLATION
- INSTALL ALL WINDOWS, DOORS AND ALL OF THEIR COMPONENTS PER MANUFACTURERS SPECIFICATIONS REQUIREMENTS FOR INSTALLATION AND WARRANTY, TYPICAL
- 4. G.C. TO VERIFY EXISTING CATWALK LOCATIONS IN ATTIC AND COORDINATE NEW CATWALKS AS REQUIRED WITH EQUIPMENT LOCATIONS, TYPICAL

#### ARCHITECTURAL LEGEND

FULLY RECESSED FIRE EXTINGUISHER CABINET FOR ONE 10# ABC FIRE EXTINGUISHER (MP SERIES). (FIRE-RATED AS REQUIRED)

FULLY ACCESSIBLE PATIENT ROOM AND BATH

NEW CONSTRUCTION

INFILL /IN PLACE CONCRETE SLAB @ HIGHER ELEVATION TO ALIGN WITH EXISTING CONCRETE FLOOR TO BE SMOOTH AND READY TO

RECEIVE NEW FLOOR FINISH. SEE STRUCTURAL DRAWINGS

Recovery Centers of America


Project

**BILLINGSLEY FACILITY BUILDING 4** 11,100 BILLINGSLEY

ROAD WALDORF, MARYLAND 220602

Thomas E Hall & Associates, Inc. 240 Conestoga Road Wayne, Pa 19087 (610) 293-9900 www.teh-architects.com

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CONTRACTOR SHALL VERIFY DIMENSIONS AND SITE CONDITIONS AND REPORT ANY DISCREPANCIES TO THE ARCHITECT. THE ARCHITECTS IS NOT RESPONSIBLE FOR ANY UNREPORTED DISCREPANCIES.

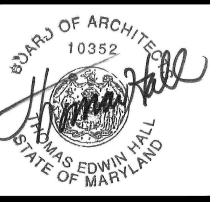Consultant

Project Type

Alteration Remodel New Addition

New Construction **Drawing Status** 

Design Phase Not For Construction

For Pricing For Permit

Revision For Construction

Revisions

No. Date 06/03/2016 REVISION #10 07/07/2016 REVISION #11 7 07/27/2016 REVISION #12

09/16/2016 REVISION #13 01/06/2017 REVISION #14


4.\ 02/03/2017 ADDENDUM# Job No: 6142.00 Drawn By:

Checked By: TEH Scale: AS NOTED Drawing Title:


ARCH. PLANS BLDG. 4.

Sheet No:

PARTIAL FLOOR PLAN BUILDING NO. 4 A-1.0 / SCALE: 1/4" = 1'-0"

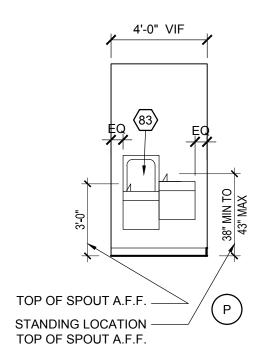


WATER FOUNTAIN ELEV. A-1.2 / SCALE: 1/4" = 1'-0"

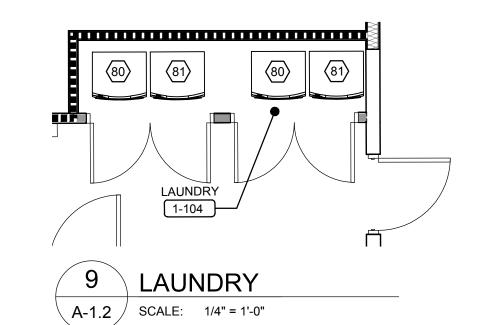


7" MIN TO 9" MAX


IN FRONT OF TOILET

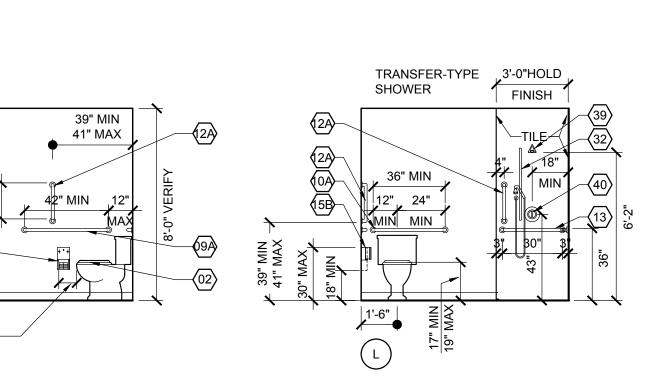

TYPICAL PRIVATE FA BATHROOM ELEVATIONS A-1.2 / SCALE: 1/4" = 1'-0"

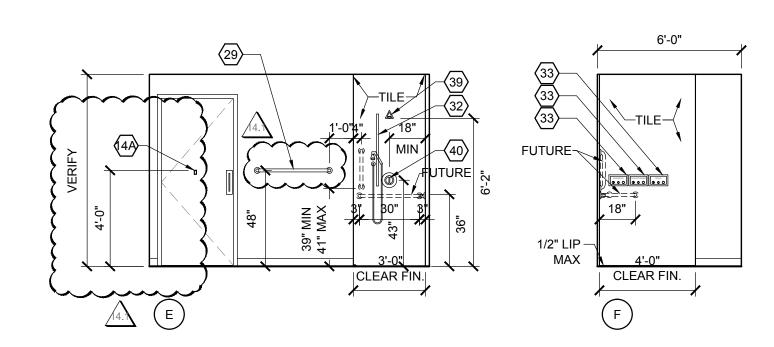

TYPICAL PRIVATE BATHROOM ELEVATIONS A-1.2 SCALE: 1/4" = 1'-0"

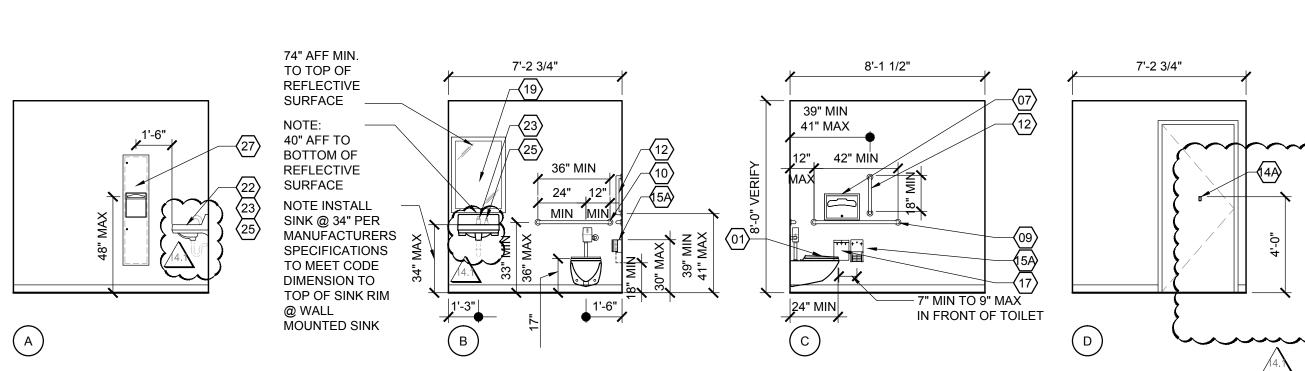

~~~~

TOP OF SINK RIM IF DROP-IN / SURFACE MOUNTED SINK


TOP OF COUNTER IF UNDERMOUNTED SINK


-TILE-


|CLEAR FIN.|


NOTE 34" DIMENSION PER CODE:

2 UNISEX TOILET ROOM ELEVATIONS A-1.2 / SCALE: 1/4" = 1'-0"

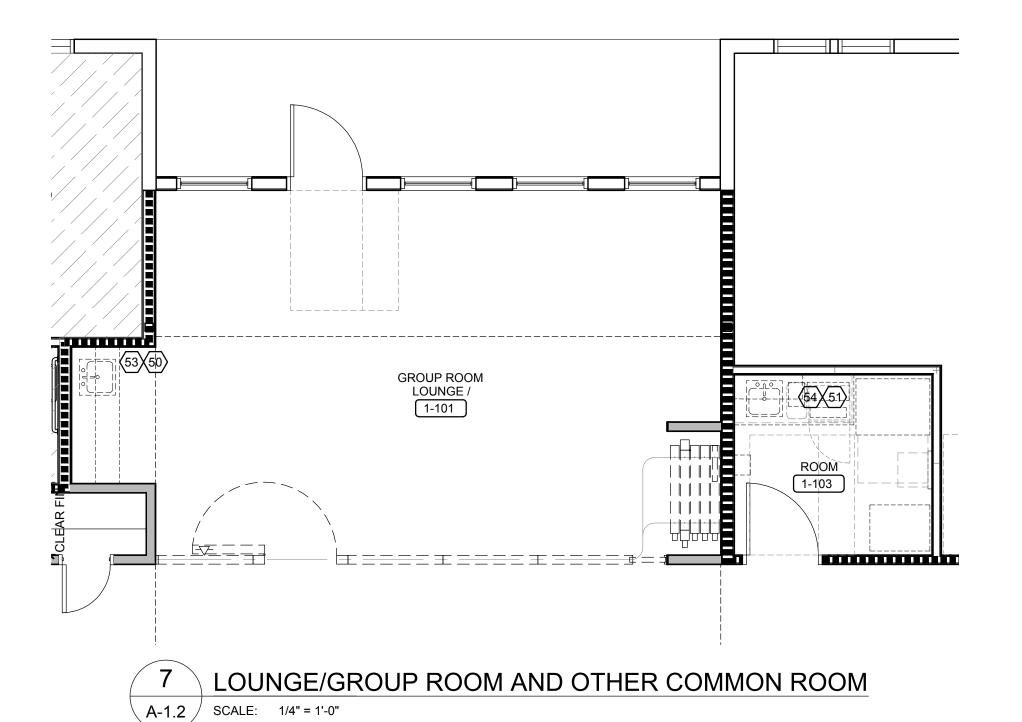

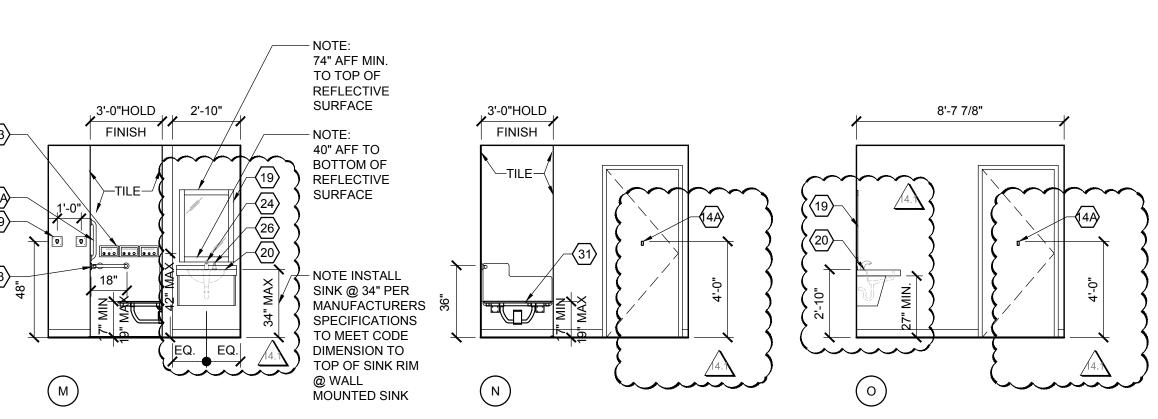

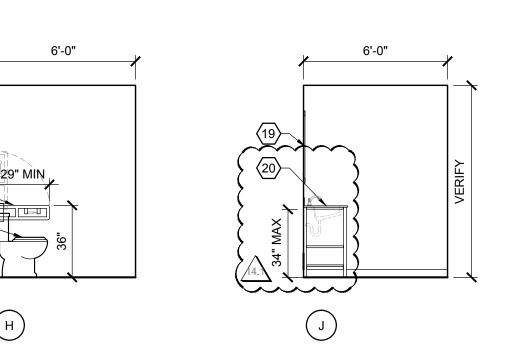

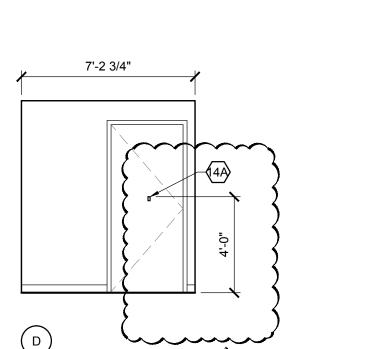


UNISEX TOILET ROOM AND OTHER COMMON ROOM PLAN A-1.2 SCALE: 1/4" = 1'-0"




COORDINATE WITH INTERIOR DESIGN DRAWINGS FOR ALL FIXTURE'S, ACCESSORIES, FINISHES AND SPECIFICATIONS.

4. TOILET ACCESSORIES TO BE **POLISHED CHROME**.


- INSTALL BLOCKING AS REQUIRED FOR FUTURE INSTALLATION OF GRAB BARS IN ALL TYPE "B" TOILET ROOMS.
- 3. WATER CLOSETS AND URINALS SHALL BE VITREOUS CERAMIC CHINA TYPICAL.
- 5. SHOWERS ALL SHOWERS TO RECEIVE TILED WALLS, SEE INTERIOR DESIGN DRAWINGS FOR SPECIFICATIONS.
- 6. ALL ACCESSORIES TO BE COORDINATED FOR CLEARANCES AROUND TOILET
- PARTITION DOORS AND DOOR SWINGS.
- 7. MOUNT / INSTALL ALL OF THE EQUIPMENT AS REQUIRED TO BE ADAAG / ANSI 117.1
- 8. PROVIDE ALL **COMMON AREA TOILETS** WITH **WALL MOUNTED** WATER CLOSET WITH
- HANDS FREE FLUSH VALVE TOILET PUSH BUTTON HIGH EFFICIENCY FLUSHOMETER

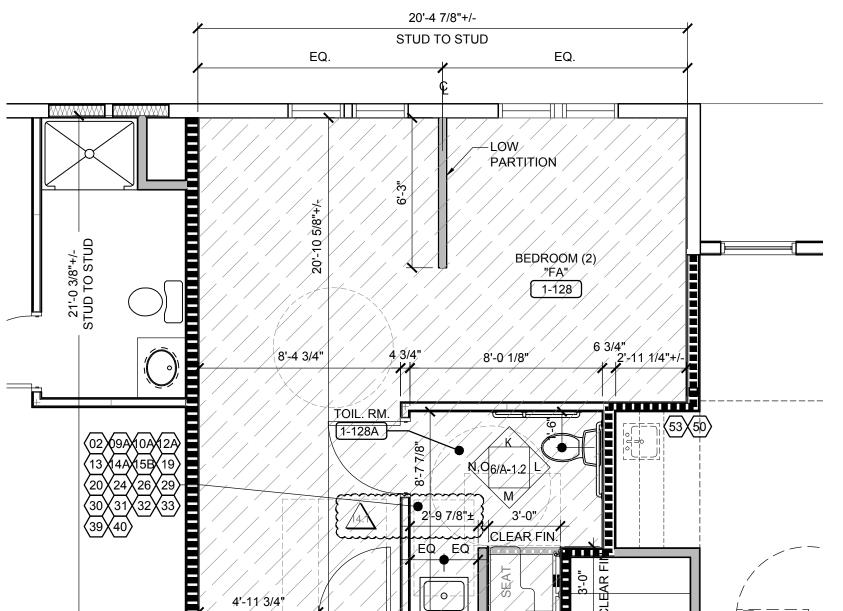

5 TYPICAL PRIVATE FA BEDROOM A-1.2 / SCALE: 1/4" = 1'-0"

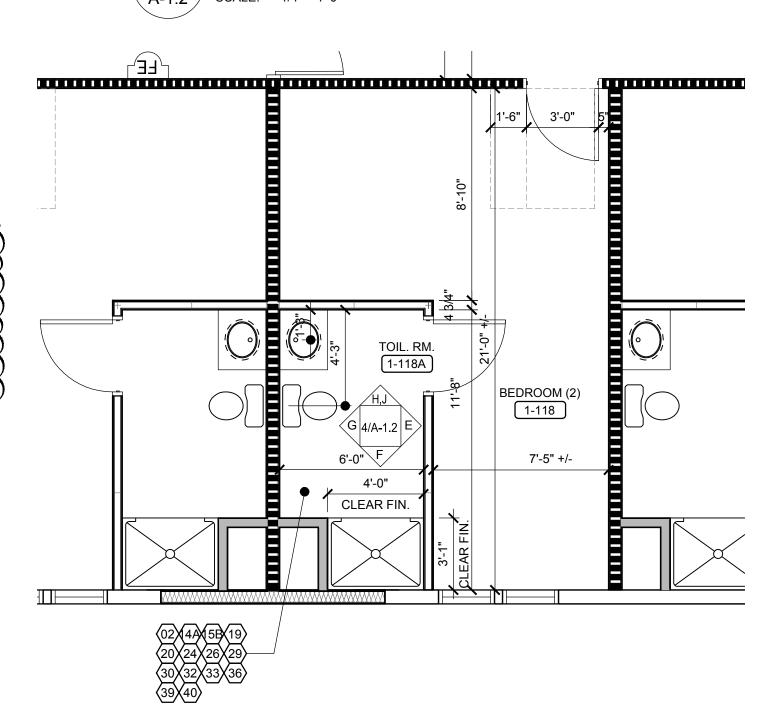

TYPICAL PRIVATE BEDROOM A-1.2 / SCALE: 1/4" = 1'-0"

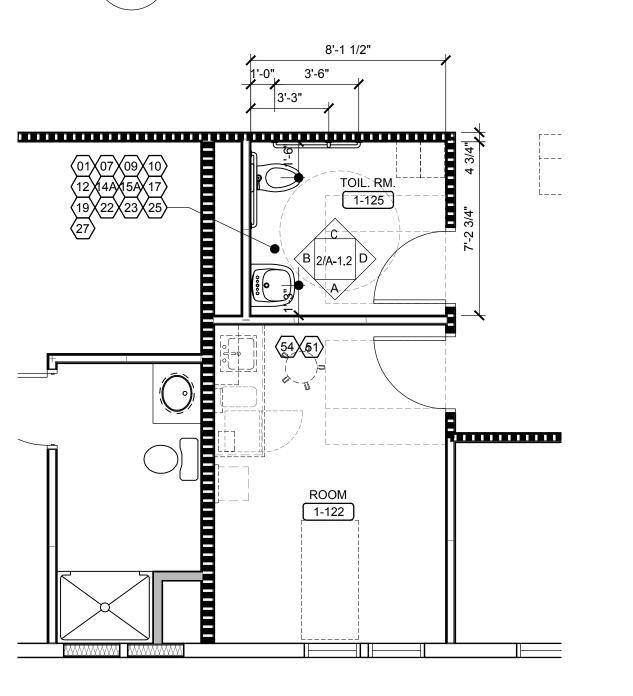

LARGE SCALE PLAN & ELEVATION NOTES

1. THE DIMENSIONS INDICATED ON THESE LARGE SCALE PLANS AND ELEVATIONS ARE FROM FINISH FACE OF GWB TO FINISH FACE OF GWB. UNLESS NOTED OTHERWISE.

#### TOILET ROOM EQUIPMENT LIST

WALL MOUNTED ADAAG / ANSI 117.1 COMPLIANT WATER CLOSET WITH HANDS FREE FLUSH VALVE

Recovery Centers of America

Project

**FACILITY** 

**BILLINGSLEY** 

**BUILDING 4** 

11,100 BILLINGSLEY

MARYLAND 220602

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Consultant

Key Plan

Project Type

Alteration

Remodel

New Addition

New Construction

**Drawing Status** 

Design Phase

For Pricing

For Permit

Revision

Revisions

No. Date

For Construction

06/03/2016 REVISION #10

07/07/2016 REVISION #11

07/27/2016 REVISION #12

09/16/2016 REVISION #13

01/06/2017 REVISION #14

02/03/2017 ADDENDUM #1

AS NOTED

Job No: 6142.00

Checked By: TEH

Drawn By:

Not For Construction

240 Conestoga Road

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Wayne, Pa 19087

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ROAD WALDORF.

- FLOOR MOUNTED WATER CLOSET ADAAG / ANSI 117.1 CODE COMPLIANT WITH LEFT OR RIGHT TRIP LEVER
- WALL MOUNTED ADAAG / ANSI 117.1 COMPLIANT URINAL WITH HANDS FREE FLUSH
- (04) WALL MOUNTED URINAL WITH HANDS FREE FLUSH VALVE (05) PAINTED METAL FLOOR MOUNTED TOILET PARTITIONS AND DOORS
- (06) PAINTED METAL WALL MOUNTED URINAL SCREEN
- (07) RECESSED TOILET SEAT COVER DISPENSER
- (08) HORIZONTAL WALL MOUNTED 48" ADAAG / ANSI 117.1 COMPLIANT GRAB BARS
- (09) HORIZONTAL WALL MOUNTED 42" ADAAG / ANSI 117.1 COMPLIANT GRAB BARS (PUBLIC TOILET ROOMS)
- HORIZONTAL WALL MOUNTED 42" ADAAG / ANSI 117.1 COMPLIANT GRAB BARS
- (PRIVATE TOILET ROOMS) (10) HORIZONTAL WALL MOUNTED 36" ADAAG / ANSI 117.1 COMPLIANT GRAB BARS
- (PUBLIC TOILET ROOMS)
- (0A) HORIZONTAL WALL MOUNTED 36" ADAAG / ANSI 117.1 COMPLIANT GRAB BARS (PRIVATE TOILET ROOMS)
- (11) HORIZONTAL WALL MOUNTED 18 21" ADAAG / ANSI 117.1 COMPLIANT GRAB BARS (PRIVATE ROLL IN SHOWER)
- (PUBLIC TOILET AND PUBLIC SHOWER)
- (2A) VERTICAL WALL MOUNTED 18" ANSI 117.1 COMPLIANT GRAB BARS (PRIVATE TOILET AND SHOWER)
- (1) ONE CONTINUOUS HORIZONTAL WALL MOUNTED GRAB BAR LH / RH SEE PLAN AT TRANSFER SHOWER AS REQUIRED ADAAG / ANSI 117.1 COMPLIANT.
- COAT HOOK ON BACK OF ALL TOILET PARTITION DOORS (ONE PER STALL). SEE INTERIOR DRAWINGS FOR DETAILS.
- PATIENT TOILET ROOMS/SINGLE PUBLIC TOILET ROOM COAT HOOKS. SEE INTERIOR DRAWINGS FOR MOUNTING LOCATIONS.
- \$\langle 15 \rangle SURFACE MOUNTED ADAAG / ANSI 117.1 COMPLIANT DOUBLE TOILET PAPER DISPENSER FOR PUBLIC GANG TOILETS
- (5A) RECESSED MOUNTED ADAAG / ANSI 117.1 COMPLIANT DOUBLE TOILET PAPER DISPENSER FOR PUBLIC TOILET ROOMS
- SURFACE MOUNTED ADAAG / ANSI 117.1 COMPLIANT DOUBLE TOILET PAPER DISPENSER FOR PRIVATE TOILET ROOMS
- (16) NOT USED (17) SURFACE MOUNTED SANITARY NAPKIN DISPOSAL FOR WOMEN'S STALLS AND
- WOMEN'S AND UNISEX TOILET ROOMS ONLY (18) RECESSED NAPKIN / TAMPON VENDOR FOR WOMEN'S GANG TOILET ROOMS ONLY
- (19) WALL MOUNTED FIXED POSITION 2" FRAMED MIRROR CODE COMPLIANT MIRROR THEFT PROOF INSTALLATION - SEE INTERIOR DRAWINGS FOR DETAILS
- GRANITE / MARBLE / QUARTZ SURFACE / SOLID SURFACE COUNTER WITH APRON TO USE WITH AN UNDERMOUNT BOWL, INCLUDE GRID DRAIN AND P-TRAP. PROVIDE REMOVABLE CABINET FOR ACCESSIBILITY AT ALL TYPICAL BATHROOMS
- GRANITE / MARBLE / QUARTZ SURFACE / SOLID SURFACE COUNTER WITH SEMI COUNTERTOP SINK WITH FAUCET, INCLUDE GRID DRAIN AND P-TRAP
- WALL MOUNTED LAVATORY WITH FAUCET, KNEE CONTACT GUARD, INCLUDE GRI
- DRAIN AND P-TRAP (23) HANDS FREE CONTROL LAVATORY FAUCET MODEL
- SINGLE LEVER SINK FAUCET CODE COMPLIANT
- (25) HANDS FREE COUNTER TOP SOAP DISPENSER
- (26) RECESSED WALL/DECK MOUNTED SOAP DISPENSER WITH SOAP VESSEL
- RECESSED PAPER TOWEL DISPENSER AND DISPOSAL ADAAG / ANSI 117.1 CODE COMPLIANT
- (28) RECESSED PAPER TOWEL DISPENSER AND DISPOSAL
- WALL MOUNTED TOWEL BAR CODE COMPLIANT INSTALL ONE PER PATIENT BATHROOM TYPICAL
- SHOWER RECEPTOR BARRIER FREE MOULDED FIBERGLASS, 2" PNC NON CAULK DRAIN, LH / RH TO BE DETERMINED, G.C. TO VERIFY RECEPTOR COMPLIES WITH CODE FOR "FA", ROLL-IN SHOWERS, TRANSFER SHOWERS AND TYPE "B" UNITS.
- ADULT FOLDING SHOWER SEAT ADAAG / ANSI 117.1 CODE COMPLIANT BARRIER FREE - SEE PLAN FOR LH / RH
- 32 SHOWER HAND SHOWER SYSTEM WITH SLIDE BAR PROVIDE ALL COMPONENTS AS REQUIRED. MOUNT AS REQUIRED TO BE ADAAG / ANSI 117.1 CODE COMPLIANT
- RECESSED SOAP/SHAMPOO/CONDITIONER DISPENSERS ADAAG / ANSI 117.1
- 34 SERVICE SINK

CODE COMPLIANT

- 35 SERVICE SINK FAUCET & SERVICE SINK FITTINGS
- PROVIDE BLOCKING FOR FUTURE (2) TWO SWING UP GRAB BARS WALL MOUNTED MINIMUM 29" LONG ADAAG / ANSI 117.1 COMPLIANT GRAB BARS PROVIDE ONE SWING UP GRAB BAR WITH INTEGRAL TOILET PAPER HOLDER
- HORIZONTAL RECESSED MOUNTED BABY CHANGING STATION ADAAG / ANSI 117.
- WALL MOUNTED FIXED POSITION 2" FRAMED FULL WIDTH MIRROR CODE COMPLIANT MIRROR THEFT PROOF INSTALLATION SEE INTERIOR DRAWINGS
- FOR DETAILS (39) TYPICAL SHOWER HEAD - OPTION RAIN SHOWER
- 40 TYPICAL DIVERTER

#### **ANCILLARY SINKS & FAUCETS EQMT. LIST**

- SINGLE LEVER FAUCET AT LOUNGE / CAFE ADAAG / ANSI 117.1 CODE COMPLIANT
- 51) SINGLE LEVER FAUCET OTHER COMMON AREA ROOMS
- UNDERMOUNT SINGLE BOWL SINK ADAAG / ANSI 117.1 CODE COMPLIANT AT GROUP ROOM/LOUNGE/COFFEE BAR
- UNDERMOUNT SINGLE BOWL STAINLESS STEEL BAR SINK ADAAG / ANSI 117.1 CODE COMPLIANTAT OTHER COMMON AREA ROOMS

### MISCELLANEOUS EQUIPMENT LIST

- (80) FRONT ELECTRIC LOADING WASHER
- (81) ELECTRIC DRYER
- 82 STACKABLE ELECTRIC FRONT LOADING WASHER AND DRYER
- (83) WALL MOUNTED TOUCHLESS ADA COMPLIANT BOTTLE FILLER STATION WITH HI/ LO - FILTERED COOLER, VANDAL RESISTANT & BARRIER FREE

TOIL. RM. PLANS & ELEV'S BLDG. 4 Sheet No:

Drawing Title: 1/4"=1'-0"


**BILLINGSLEY BUILDING 4** 

A-1.2

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Project Type

Alteration

Remodel New Addition New Construction

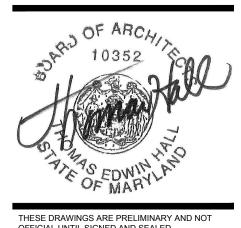**Drawing Status** 

Design Phase Not For Construction

For Pricing For Permit

For Construction

06/03/2016 REVISION #10

07/07/2016 REVISION #11

07/27/2016 REVISION #12

09/16/2016 REVISION #13

01/06/2017 REVISION #14

4.\ 02/03/2017 ADDENDUM #1

Revision

Revisions

No. Date

HOUSING, TYPICAL. SYMBOL INDICATES THE APPROXIMATE DIMENSION FROM FLOOR TO FINISH CEILING. ALL DIMENSIONS TO FIELD VERIFIED, TYPICAL.

### REFLECTED CEILING PLAN GENERAL NOTES

REFLECTED CEILING PLAN LEGEND

INDICATES EXTERIOR LIGHT FIXTURE

SEE ELECTRICAL LIGHTING PLAN FOR FIXTURE TYPE

INDICATES / CEILING IS 1 HOUR RATED


- 1. SEE INTERIOR DESIGN DRAWINGS FOR CEILING FINISHES, SOFFITS, DETAILS, SECTIONS,
- 2. CEILING PLAN SHALL BE USED FOR FIRE RATINGS AND CEILINGS HEIGHTS ONLY. REFER
- TO THE APPROPRIATE DISCIPLINE DRAWINGS FOR MORE INFORMATION.
- 3. FINAL FIXTURE SELECTION BY OWNER / INTERIOR DESIGNER.
- 5. ALL BEARING WALLS, COLUMNS, CORRIDOR CEILINGS AND BETWEEN FLOORS SHALL BE ONE HOUR FIRE RATED

  TYPICAL CEILING / ROOF:

  TYPICAL INTERIOR WALL:

  UL DESIGN NO. U 3 3 3

  UL DESIGN NO. U 3 3 3
- UL DETAILS SHOWN ARE FOR REFERENCE ONLY PLEASE CONSULT THE UL DESIGN
- 6. ALL FIXTURES IN ONE HOUR FIRE RATED CEILING LOCATIONS TO BE ONE HOUR FIRE RATED FIXTURES, TYPICAL. COORDINATE LAMPING AS REQUIRED, TYPICAL
- 7. ALL LIGHTING, SPEAKERS, CAMERAS, DUCTWORK AND SPRINKLER HEADS SHOWN ARE

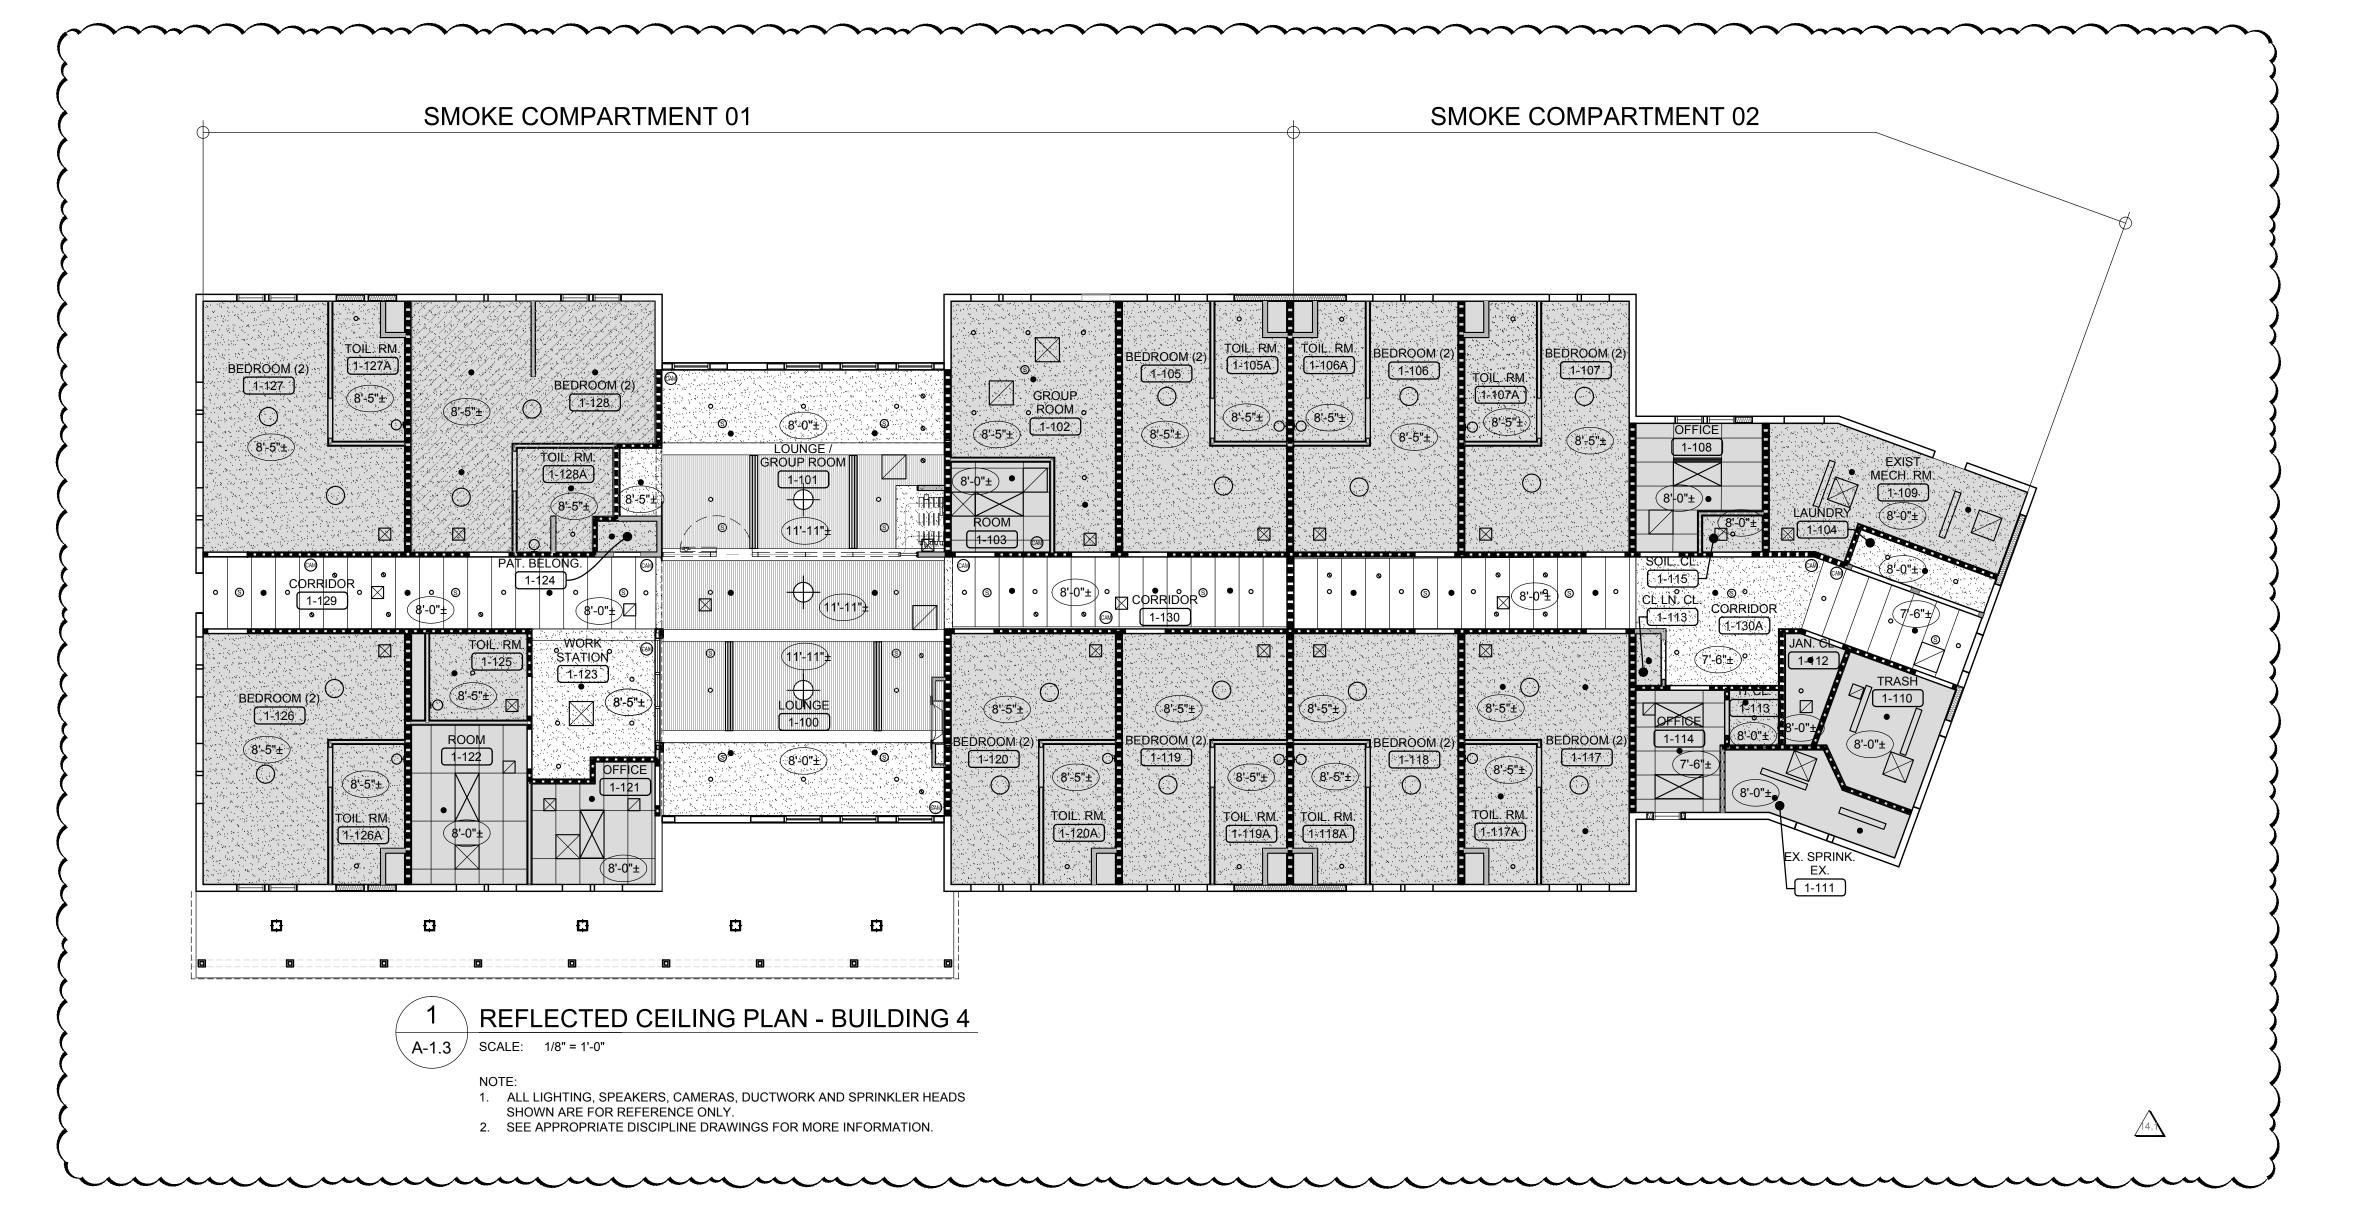

PROVIDE GWB FIRE RATED CEILING ASSEMBLY WITH NON-RATED

INTERIOR DESIGN DRAWINGS RECESSED LIGHT FIXTURE

ACCOUSTICAL DROP CEILING WITH RECESSED LIGHT FIXTURES. SEE

INTERIOR DESIGN DRAWINGS. VERIFY FINISH CEILING HEIGHT WITH

- 4. FINAL COLOR / FINISH SELECTION BY OWNER / INTERIOR DESIGNER.
- DIRECTORY FOR COMPLETE LISTING OF MANUFACTURERS AND PROPER ASSEMBLY.
- FOR REFERENCE ONLY. SEE APPROPRIATE DISCIPLINE DRAWINGS FOR MORE INFORMATION.

Job No: 6142.00 Drawn By: Checked By: TEH 17 FEB 03 AS NOTED Scale: Drawing Title: 1/8"=1'-0"

**BUILDING 4** Sheet No:

RCP& CLG HEIGHTS

UL DESIGN NO. P522

- PITCHED OR PARALLEL CHORD WOOD TRUSSES @ 48" O.C. MAX

- RC-1 CHANNEL OR EQUIVALENT, 16" O.C. WITHOUT INSULATION, 12" O.C. WITH INSULATION

1-HR RATING

- INSULATION OPTIONAL IN CONCEALED SPACE DIRECTLY OVER GYPSUM CEILING

- Š/Š" ŠHĚĚŤŘŎČK)BRAND FIRECODE "C" OR "X" CORE GYPSUM PANELS

DETAIL - UL DESIGN P522

- ROOF SYSTEM OVER 15/32" PLYWOOD SHEATHING

- OPTIONAL BATTS AND BLANKETS INSULATION


USG DGL DRYWALL SUSPENSION SYSTEM


SYSTEM DESCRIPTION ROOF CEILING ASSEMBLY

**A-1.3** / SCALE: 1-1/2" = 1'-0"


- AIR DUCT - CEILING DAMPER


MEMBRANE

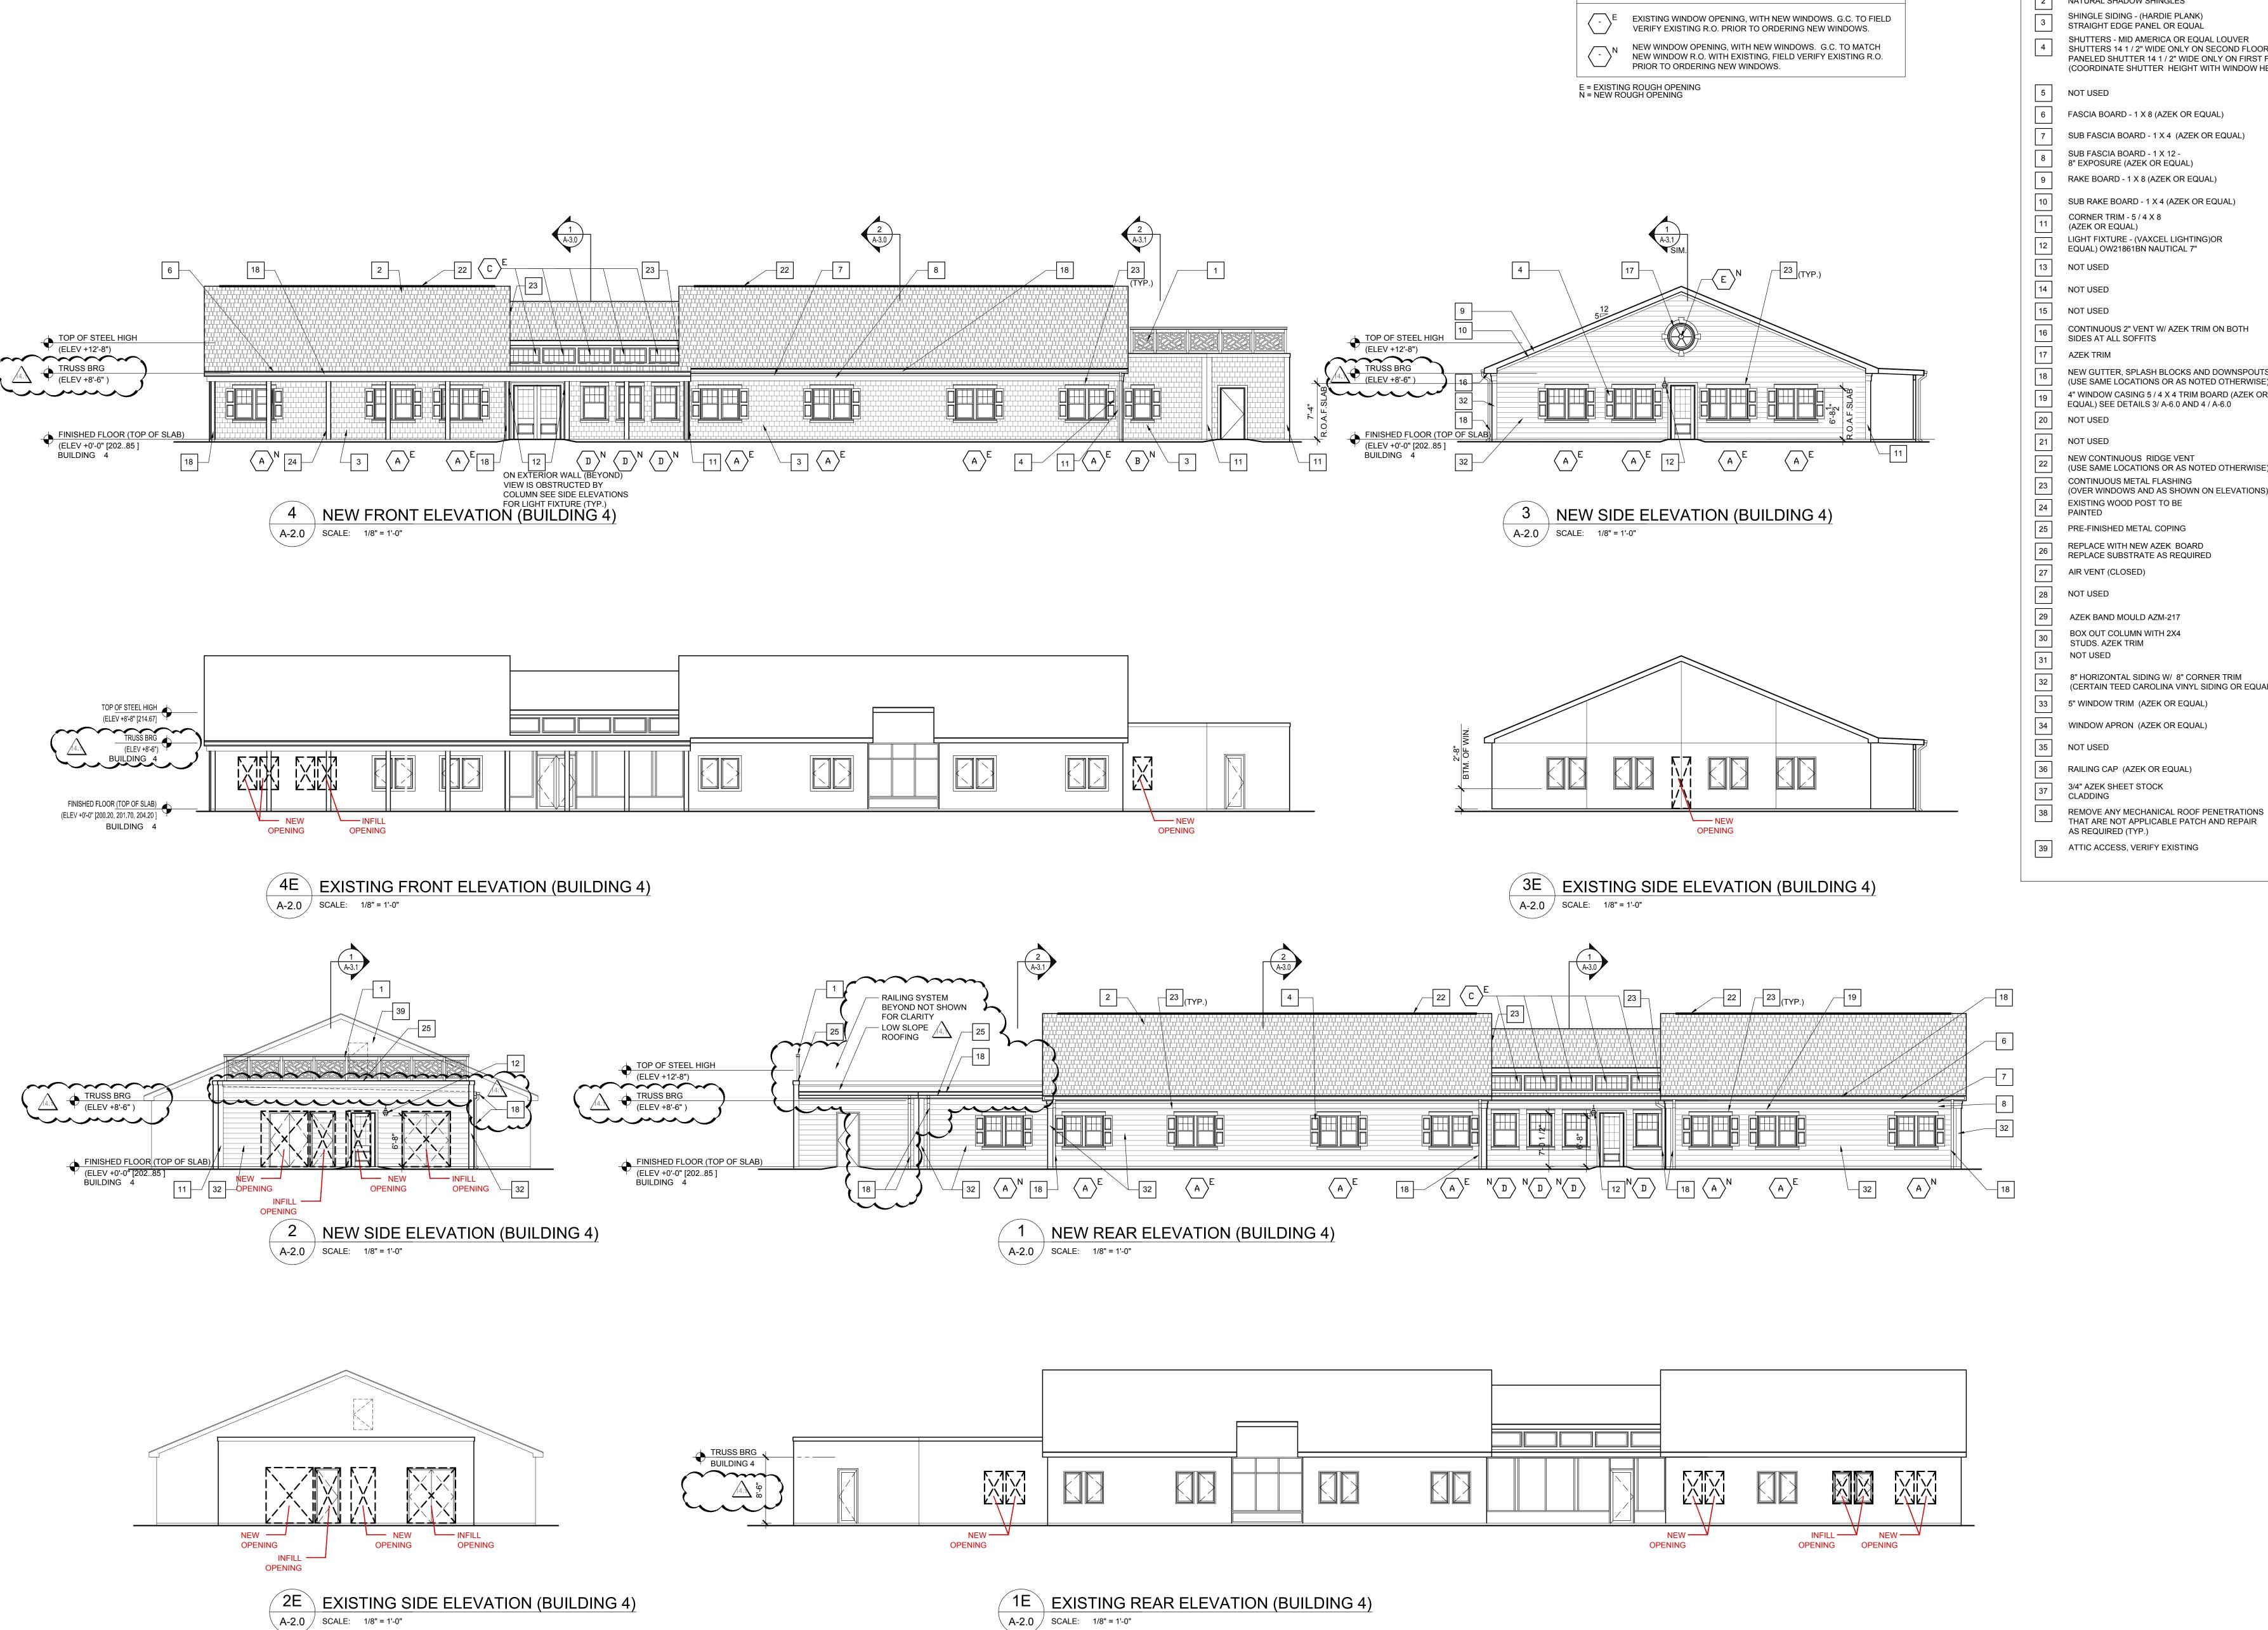

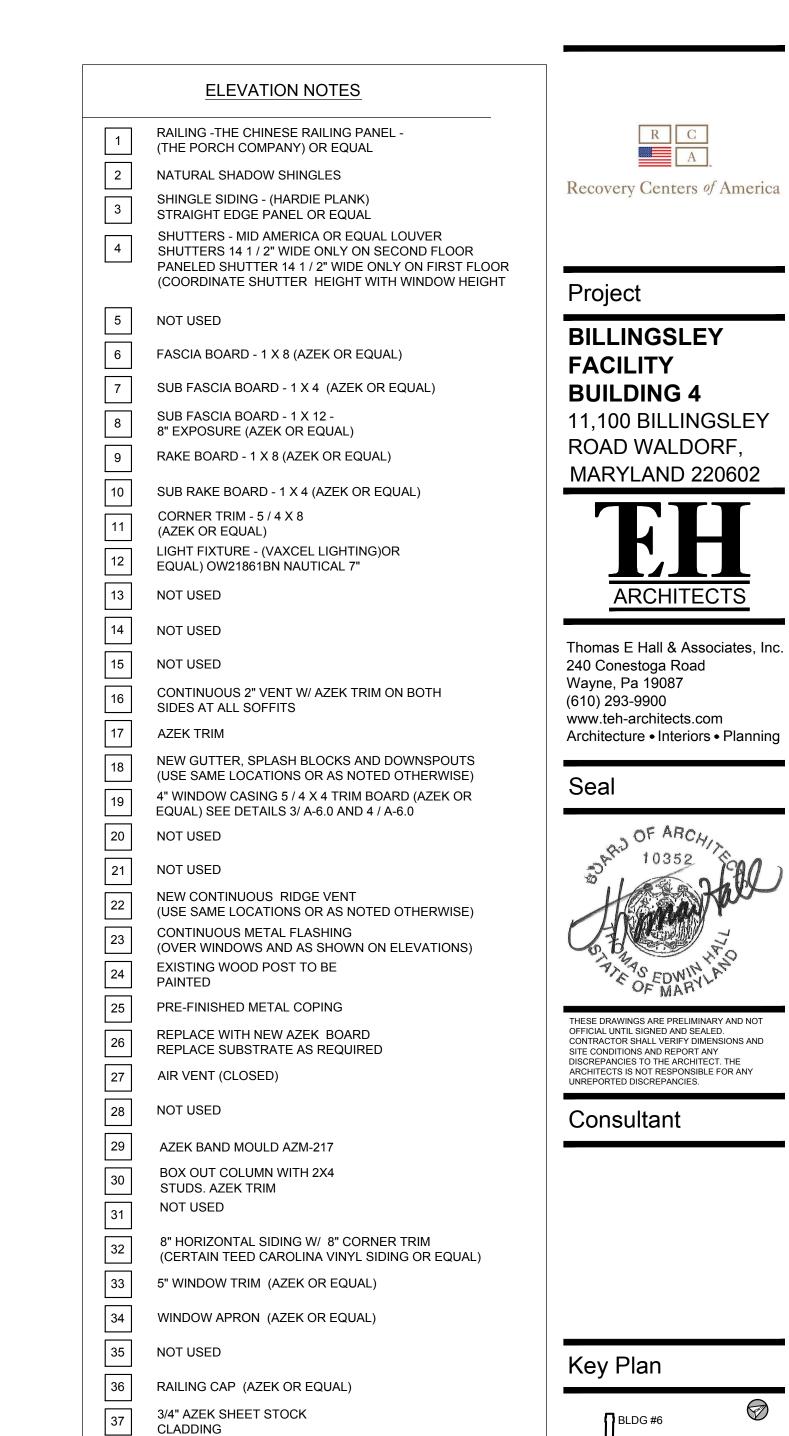

WINDOW KEY LEGEND

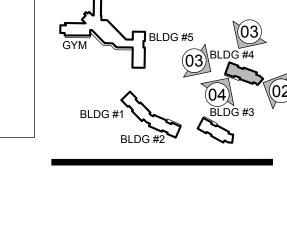

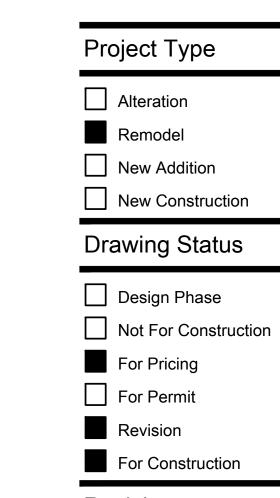

| Revisions     |               |              |  |  |  |  |
|---------------|---------------|--------------|--|--|--|--|
| No.           | Date          | Description  |  |  |  |  |
| 10            | 06/03/2016    | REVISION #10 |  |  |  |  |
| $\Lambda$     | 07/07/2016    | REVISION #11 |  |  |  |  |
| 12            | 07/27/2016    | REVISION #12 |  |  |  |  |
| 13            | 09/16/2016    | REVISION #13 |  |  |  |  |
| 14            | 01/06/2017    | REVISION #14 |  |  |  |  |
| <u>/14.1\</u> | 02/03/2017    | ADDENDUM #1  |  |  |  |  |
|               | No:<br>wn By: | 6142.00      |  |  |  |  |
| Che           | cked By:      | TEH          |  |  |  |  |

Scale:

Drawing Title:

ARCH. ELEVATIONS BLDG 4 Sheet No:

17 FEB 03

AS NOTED

**BILLINGSLEY** 

**FACILITY** 

**BUILDING 4** 

11,100 BILLINGSLEY

MARYLAND 220602

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Consultant

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Wayne, Pa 19087

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ROAD WALDORF,

m

PROVIDE

PERSON

ACCESS

THRU

ATTIC

**NEW BEAM WITH** 

CONTINUOUS SOLID

BLOCKING BETWEEN SEE

STRUCTURAL DRAWINGS

NEW CEILING FRAMING FOR  $\,-\,$ NEW GWB CEILING LOCATION VERIFY FINISH W/ INTERIOR

DESIGNER SEE STRUCTURAL

APPROXIMATE LOCATION OF —

BEAM IN WALL BEYOND SHOWN

LOUNGE

CORRIDOR

BEYOND

- EXISTING CONCRETE SLAB

A-3.0 / SCALE: 1/2" = 1'-0"

BUILDING 4 - SECTION

DRAWINGS FOR FRAMING

EXISTING BOTTOM OF STEEL

DOTTED

TYPICAL +

VERIFY EXISTING STEEL RIDGE

STEEL ANGLE BRACES TO RIDGE

HARDIE PLANK SHINGLE SIDING (OR EQUAL) 7" EXPOSURE WITH

CONCEALED FLASHING TYPICAL

the state of the s

mmmmmm

MILLWORK & WINDOWS ARE

INTERIOR DESIGN DRAWINGS

INDICATED FOR REFERENCE ONLY.

MILLWORK TO BE COORDINATED WITH

8" CORNER BOARDS TYPICAL

APPROXIMATE LOCATION OF ORIGINAL COLLAR TIE

July 1

G.C. FIELD VERIFY EXISTING WOOD TRUSS FRAMING

EQUIPMENT AND DUCT SIZES TYPICAL)

PATTERN BEYOND AND STEEL POST AND STEEL BRACE

LOCATIONS. INSTALL HVAC EQUIPMENT AND DUCTS TO AVOID CONFLICTS, TYPICAL (NOTE G.C. VERIFY ACTUAL

FIELD VERIFY

HEADER HEIGHT

AND COORDINATE

\_`WITH DOOR SIZE


\_EXISTING 8" CMU FOUNDATION—

EXISTING CONCRETE FOOTING

WALL

BEAM LOCATION TYPICAL

VERIFY EXISTING STEEL POST AND -

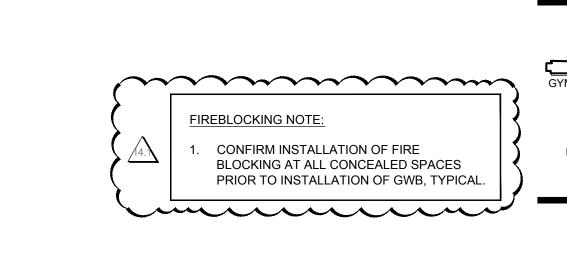

- 8" HORIZONTAL SIDING

WITH 8" CORNER TRIM

(OR EQUAL) TYPICAL

METAL DRIP EDGE

FLASHING TYPICAL

CERTAINTEED

A My J

CAROLINA VINYL SIDING T.O EXISTING WOOD PLATE

- NEW PRE-FINISHED

METAL SOFFIT

PANELS VENTED

- NEW PRE-FINISHED

OF BUILDING)

METAL TRIM BANDS (AT REAR AND SIDES

T.O. SLAB

BOTTOM OF NEW CLG JOIST

INSTALL NEW CONTINUOUS RIDGE VENT AT EXISTING AND

ASPHALT SHINGLES OVER 15#

SHEATHING THICKNESS, AND

INSTALLATION OF NEW ROOFING

VERIFY EXISTING ROOF

- EXISTING ROOF FRAMING

FACE OF G.W.B. TYPICAL

SEE STRUCTURAL DRAWINGS

INSTALL ICE & WATER SHIELD MEMBRANE 2'-0" BEYOND INTERIOR

INSTALL CONCEALED FLASHING

CONDITION PRIOR TO

**NEW ROOF AREAS** 

ROOFING FELT

MATERIALS

TYPICAL

- METAL DRIP EDGE

FLASHING TYPICAL

2'-0"

VERIFY PITCH ,

NÈW WINDOWS IN EXISTING

FOR CLARITY

BATT INSULATION

ROUĞH OPENINGS NOT SHOWN

VERIFY EXISTING CAVITY FOR

EXISTING STEEL COLUMNS IN -

WALL BEYOND TYPICAL

Project Type Alteration

> Remodel New Addition New Construction

**Drawing Status** 

SECTIONS Sheet No: A - 3.0

BILLINGSLEY BUILDING 4

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RWC ON ROOF -

METAL DRIP EDGE-

PROVIDE TURN OUT AND SPLASH — BLOCKS WHERE TERMINATING AT

GRADE TYPICAL

WEEP FLASHING AT ----

BOTTOM OF HARDIPLANK

SINGLE PLY MEMBRANE -

ROOFING TERMINATION

SINGLE PLY MEMBRANE -

ROOFING OVER EXISTING

(REPLACE AS REQUIRED)

1/4" ± VERIFY ----

AND SEALANT BELOW

WEEP FLASHING

ROOF SHEATHING

SHINGLE SIDING

CONCEALED FLASHING TYPICAL

Design Phase Not For Construction For Pricing For Permit Revision For Construction T.O PLATE / BOTTOM OF TRUSS Revisions No. Date 06/03/2016 REVISION #10 07/07/2016 REVISION #11 7 07/27/2016 REVISION #12 09/16/2016 REVISION #13 01/06/2017 REVISION #14 02/03/2017 ADDENDUM #1 Job No: 6142.00 Drawn By: Checked By: TEH 17 FEB 03 AS NOTED Scale: **Drawing Title:** ARCHITECTURAL



Project


BILLINGSLEY
FACILITY
BUILDING 4
11,100 BILLINGSLEY
ROAD WALDORF,

ARCHITECTS

MARYLAND 220602

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UNREPORTED DISCREPANCIES.

Key Pla

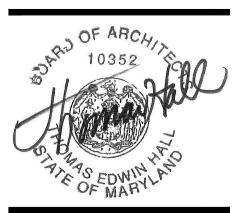BLDG #6

BLDG #5

BLDG #4

BLDG #2

BLDG #3

FIREBLOCKING NOTE:

1. CONFIRM INSTALLATION OF FIRE
BLOCKING AT ALL CONCEALED SPACES
PRIOR TO INSTALLATION OF GWB, TYPICAL.

Project Type

Alteration
Remodel

New AdditionNew Construction

Drawing Status

Design Phase

Not For Construction
For Pricing

For Permit

Revision
For Construction

Revisions

No. Date Description

06/03/2016 REVISION #10

07/07/2016 REVISION #11

07/27/2016 REVISION #12

09/16/2016 REVISION #13

01/06/2017 REVISION #14

02/03/2017 ADDENDUM #1


Job No: 6142.00
Drawn By:


Checked By: TEH
Date: 17 FEB 03

Date: 17 FEB 03
Scale: AS NOTED
Drawing Title:

ARCHITECTURAL
SECTIONS
Sheet No:

Sheet No:
A-3.1

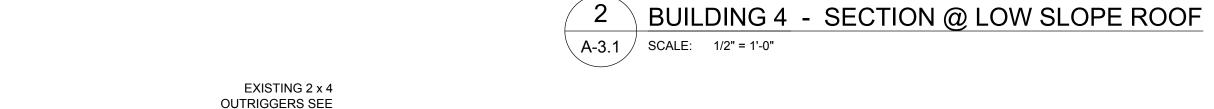

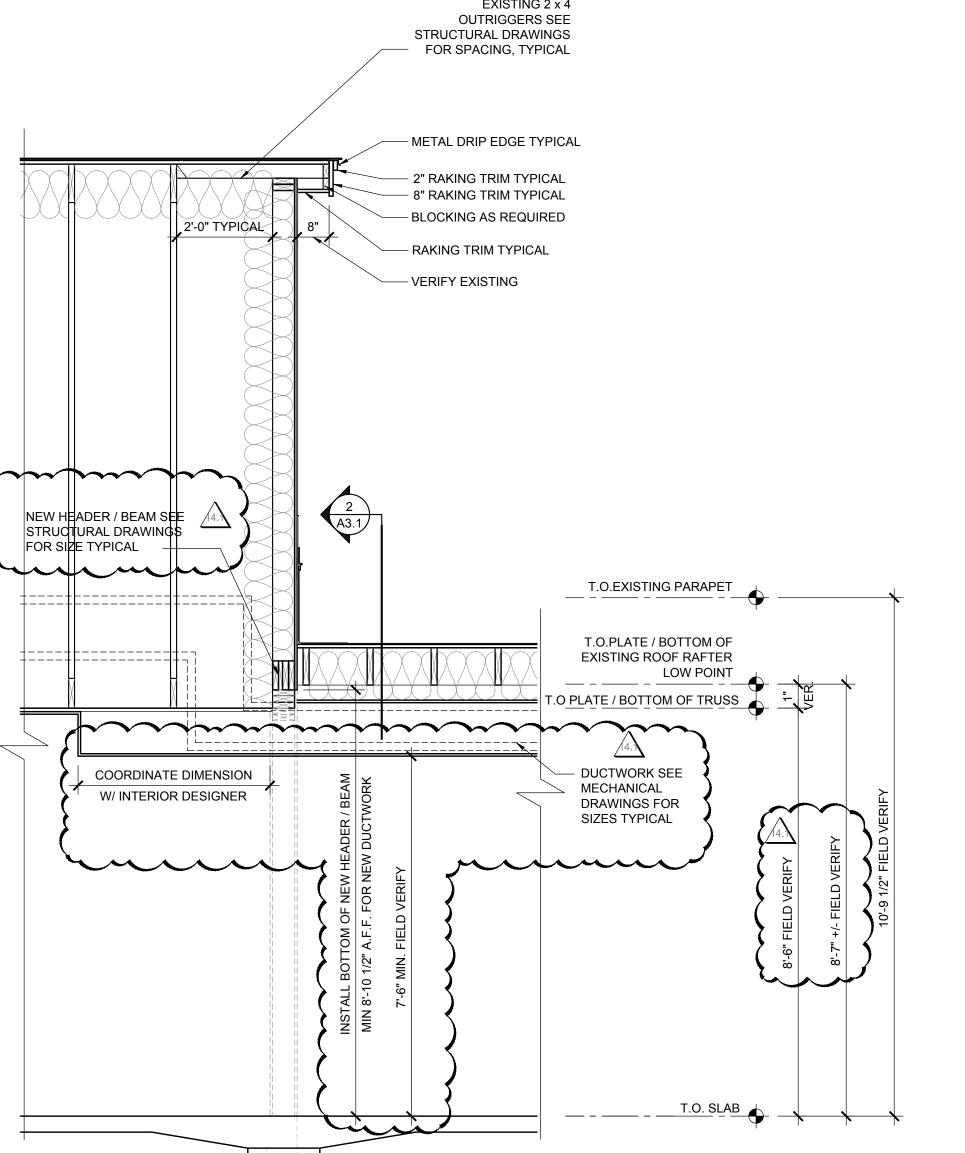

HANDRAIL

4 9/16 " SQ FINISH POST SLEEVE W/ CAP

T.O.POST

T.O. PARAPET

T.O. FINISH ROOFING

THE PORCH Co.

CHINESE RAILING PANEL

BOTTOM RAIL

BUILDING 4 - FLAT ROOF RAILING DETAIL

SCALE: 1/2" = 1'-0"

4 POST MOUNTING DETAIL

A-3.1 SCALE: 3/4" = 1'-0"

FINISH POST SLEEVE W/ BASE & CAP

ANCHOR POST TO ROOF STRUCTURE W/ Fiberon POST SLEEVE SURFACE

MOUNT SYSTEM ANCHOR W/ SUPPLIED WOOD LAGS

- WEATHER SEAL ALL PENETRATIONS FOLLOW ROOFING MANUFACTURER

RECOMMENDATIONS AND PROCEDURES

∕ 4X4 POST

11,100 BILLINGSLEY

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Project Type Alteration

Remodel New Addition New Construction

**Drawing Status** Design Phase

Not For Construction

For Pricing For Permit

Revision

For Construction Revisions

No. Date Description 06/03/2016 REVISION #10 07/07/2016 REVISION #11 07/27/2016 REVISION #12


09/16/2016 REVISION #13 01/06/2017 REVISION #14


02/03/2017 ADDENDUM #1

Job No: 6142.00 Drawn By: Checked By: TEH 17 FEB 03 AS NOTED Scale: Drawing Title:

FLASH. ROOF & PART. DETAILS Sheet No:


> A-4.0 BILLINGSLEY BUILDING 4

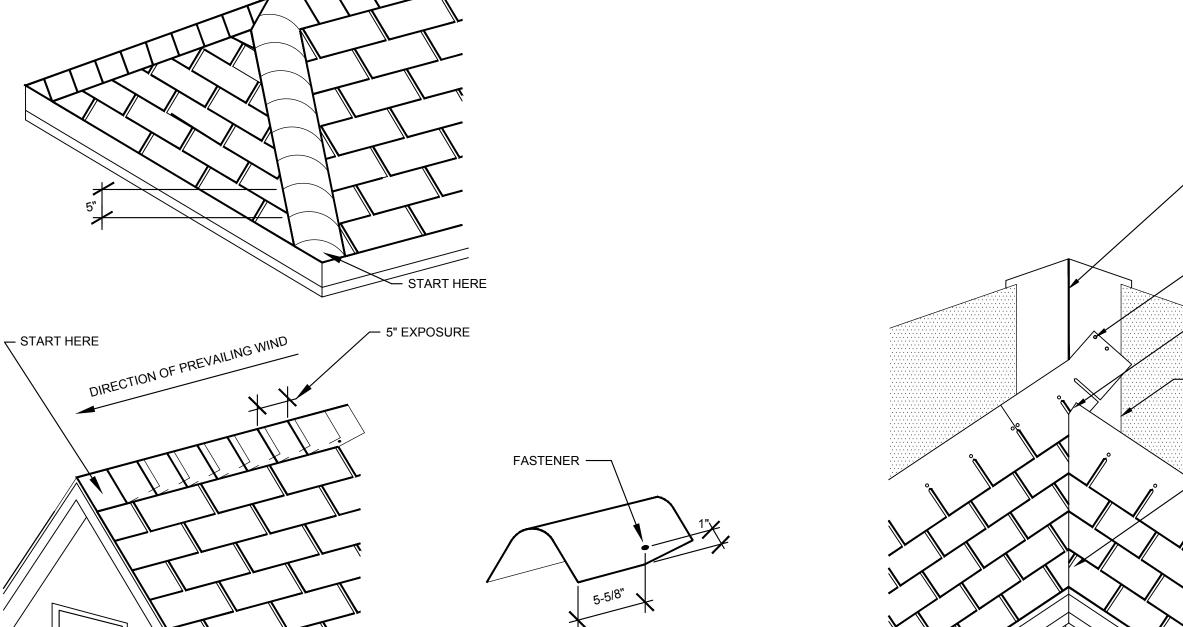

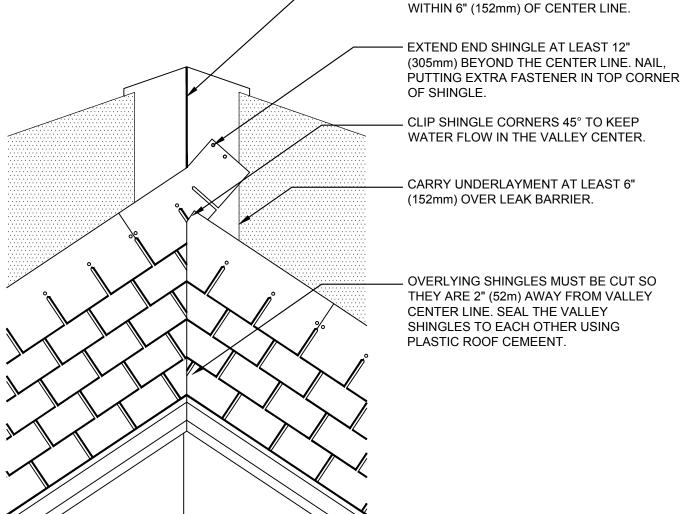

- CENTER FULL WIDTH ROLL OF LEAK

BARRIER. DO NOT PLACE FASTENERS

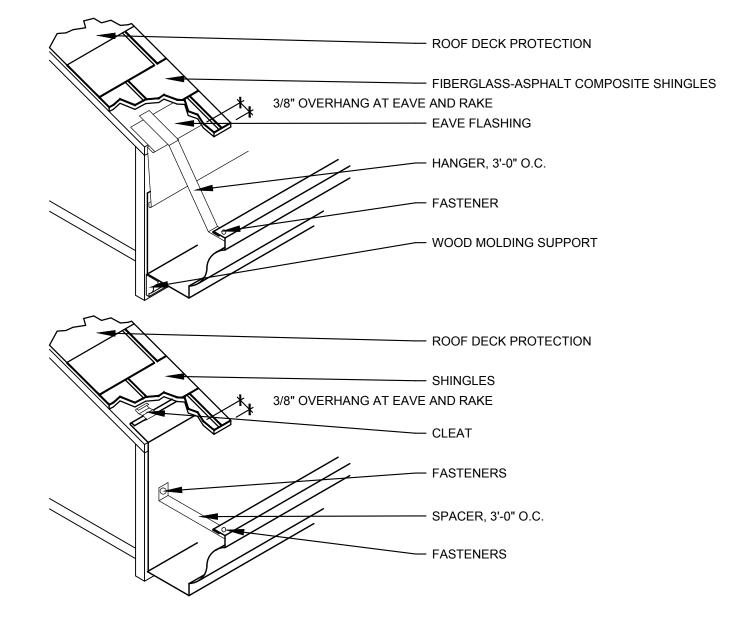


11 DETAIL - TYPICAL GUTTER INSTALLATION

A-4.0 SCALE: 1 1/2" = 1'-0"

10 DETAIL - TYPICAL WOVEN VALLEY

A-4.0 SCALE: 1 1/2" = 1'-0"

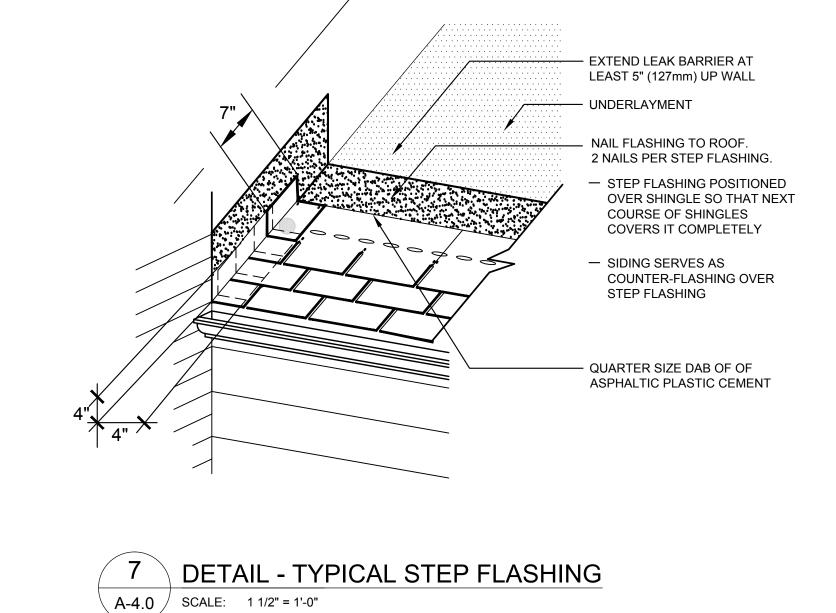

A. INSTALL 1/4" LATH STRIP ALONG

B. INSTALL SILL FLASHING TAPE #2


ALONG SILL SECTION OF ROUGH


SILL (SILL DAM).

OPENING.

DETAIL - TYPICAL RIDGE / HIP

A-4.0 / SCALE: 1 1/2" = 1'-0"

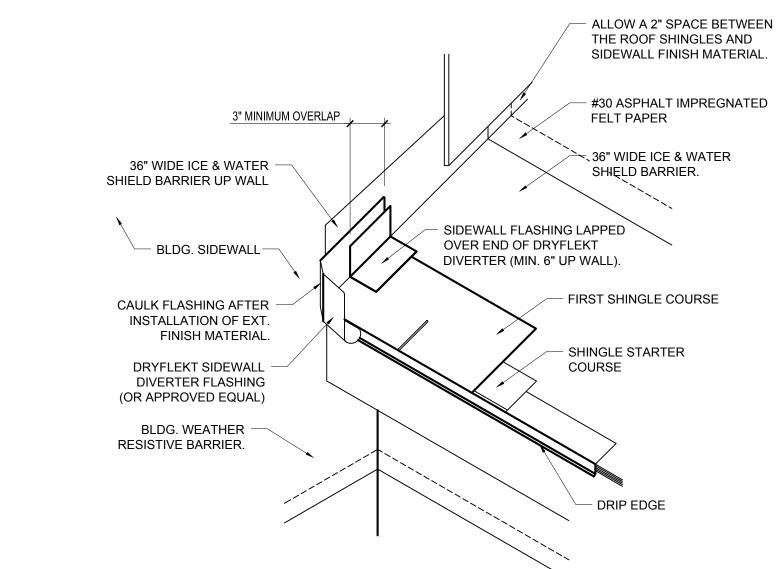

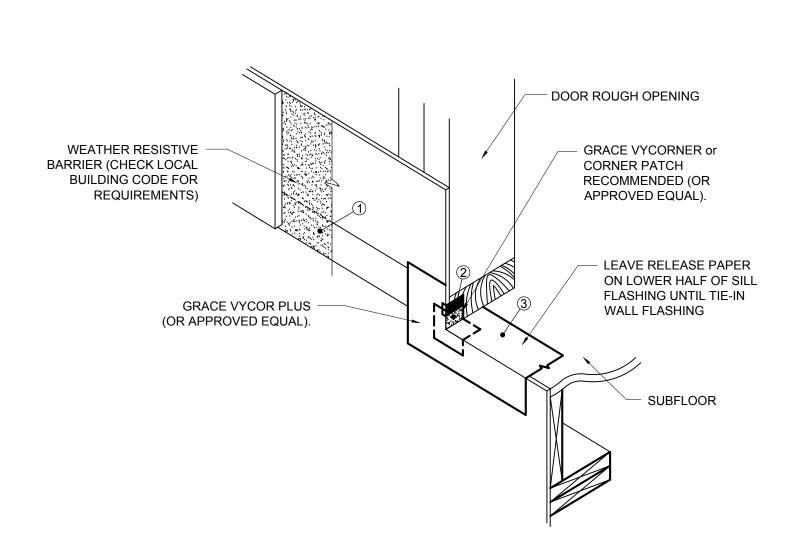


5 DETAIL - DOOR SILL FLASHING

A-4.0 SCALE: 3/4" = 1'-0"

DETAIL - SIDEWALL DIVERTER A-4.0 / SCALE: 3/4" = 1'-0"



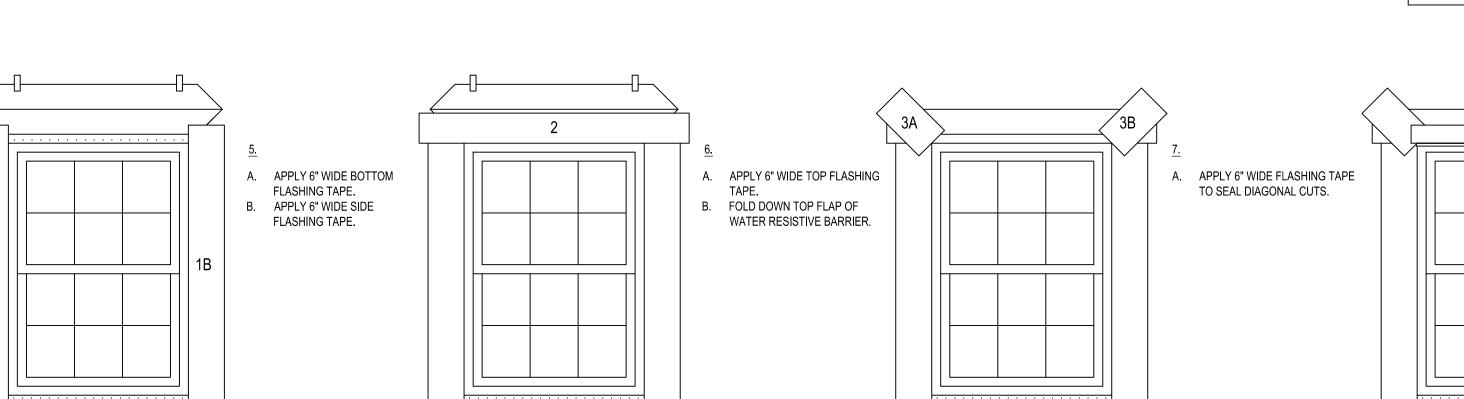

MAKE SURE SILL PLATE IS LEVEL.

ALONG SILL SECTION OF ROUGH

B. INSTALL SILL FLASHING TAPE

C. FLASHING SHOULD CAUSE A DAM

AT BOTH ENDS.

LOCATE ALL FASTENERS WITHIN 1/2" OF THE EDGE OF THE FLASHING

CUT SHINGLES TO FIT AROUND FLASHING

LEAD JACK OR PRE-FLASHED PLUMBING VENT

— WOOD DECK

COMPLETELY COVER THE DECK
 WITH TWO LAYERS OF ROOF DECK

- EXPOSURE WILL VARY DEPENDING ON UNDERLAYMENT USED. FOLLOW APPLICATION INSTRUCTIONS ON

SELECTED UNDERLAYMENT FOR

\_ALONG EAVES, PUT LEAK BARRIER

ON TOP OF NON- CORROSIVE METAL

PROTECTION AS SHOWN.

PROPER EXPOSURE.

DRIP EDGE.

- LEAK BARRIER MUST NOT

BY MORE THAN 1/4" (6mm)

OVERHANG THE EAVE EDGE

TO LEAVE A 1/4" CHANNEL

DETAIL - TYPICAL ROOF VENT FLASHING

DETAIL - TYPICAL UNDERLAYMENT

A. WRAP BUILDING W/ WEATHER

B. CUT BARRIER AS SHOWN FOR

C. 4TH CUT TO BE ABOVE WINDOW OPENING & TEMPORARILY SECURE

D. FOLD BARRIER INTO OPENING &

STAPLE TO INSIDE WALL.

RESISTIVE BARRIER.

WINDOW OPENING.

ABOVE OPENING.

- WINDOW OPENING

1.) INSTALL 24" LEAK BARRIER TARGET SHEET.

A-4.0 SCALE: 1 1/2" = 1'-0"

2.) DO NOT FACE NAIL THE PLUMBING VENT FLASHING.

· ALONG RAKE, PUT

PROTECTION.

∠LEAK BARRIER SHOULD EXTEND 24" (610mm) BEYOND THE INSIDE

A-4.0 SCALE: 1 1/2" = 1'-0"

1ST CUT

3RD CUT

2ND CUT—


WALL LINE.

WEATHER RESISTIVE BARRIER

NON-CORRODING METAL DRIP

EDGE ON TOP OF ROOF DECK

- LEAK BARRIER

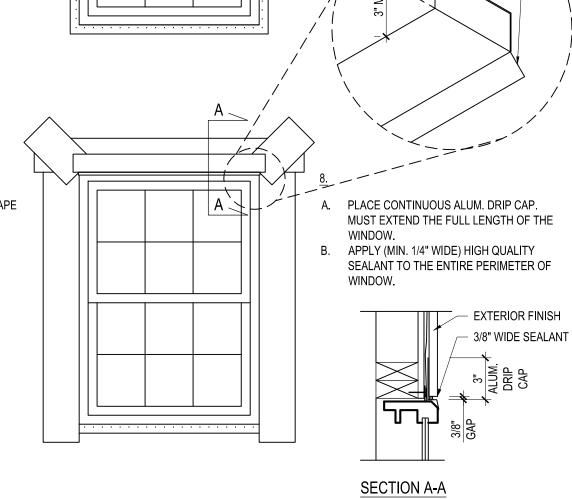

A. INSTALL WINDOW IN OPENING

(FOLLOW MAUF. INSTRUCTIONS).

LIP OR HEMMED EDGE -

UPTURNED METAL EDGE —

DETAIL - TYPICAL WINDOW FLASHING A-4.0 / SCALE: 3/4" = 1'-0"

TAPE AT ALL JOINTS.

INTERIOR SHEATHING

WOOD FRAMING

**DETAIL - WEATHER PROTECTIVE BARRIER** A-4.1 / SCALE: 1-1/2" = 1'-0"

LEAVE APPROPRIATE -

GAP AND CAULK

A-4.1 / SCALE: 3" = 1'-0"

HARDIETRIM® BOARDS -

LEAVE APPROPRIATE GAP

WATER RESISTIVE BARRIER

HARDIEWRAP™ OR EQUIVALENT

EXTERIOR SHEATHING -

HARDIEPLANK® LAP SIDING —

6 DETAIL - SIDING INSIDE CORNER


INSULATION

WHERE REQ'D -

AND CAULK

- EXTERIOR SHEATHING

• SEAL ALL TYPAR / WRB JOINTS AND PENETRATIONS WITH APPROVED TAPE. FASTEN BARRIER TO SHEATHING WITH LARGE HEAD NAILS OR USE NAILS WITH LOCAL LAWS, ZONING, AND BUILDING CODES VARY AND THEREFORE GOVERNS OVER MATERIAL SELECTION AND DETAILING SHOWN BELOW.

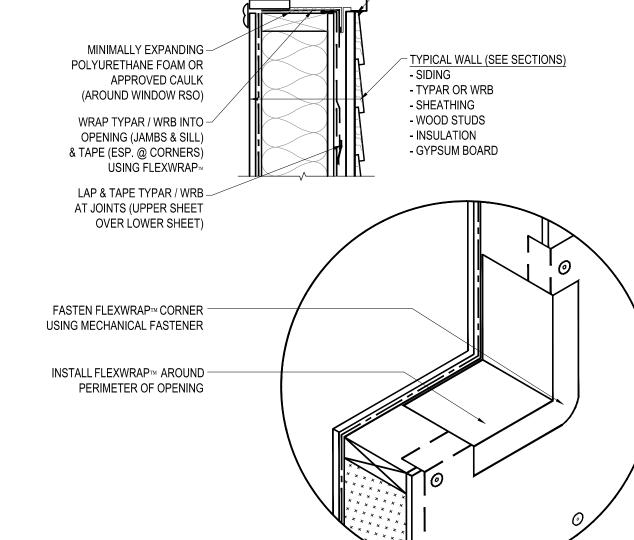

12 DETAIL - WINDOW SILL FLASHING A-4.1 / SCALE: 1-1/2" = 1'-0"

INSULATION

WHERE REQ'D -

INTERIOR SHEATHING ---

WOOD FRAMING —

— HARDIEPLANK® LAP SIDING

A-4.1 / SCALE: 3" = 1'-0"

- HARDIEPLANK® LAP SIDING

WATER RESISTIVE BARRIER

- EXTERIOR SHEATHING

- LEAVE APPROPRIATE GAP

- HARDIETRIM® BOARDS


AND CAULK

- LEAVE APPROPRIATE GAP


AND CAULK

DETAIL - SIDING OUTSIDE CORNER


HARDIEWRAP™ OR EQUIVALENT

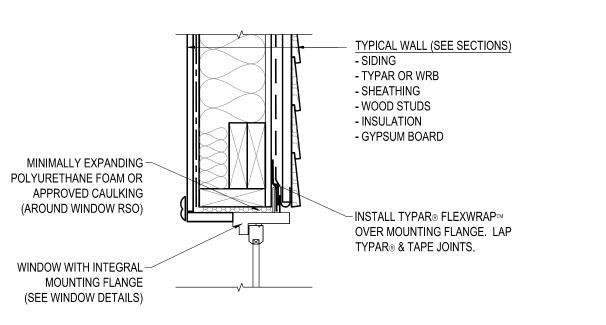


DETAIL - WINDOW HEAD FLASHING **A-4.1** / SCALE: 1-1/2" = 1'-0"

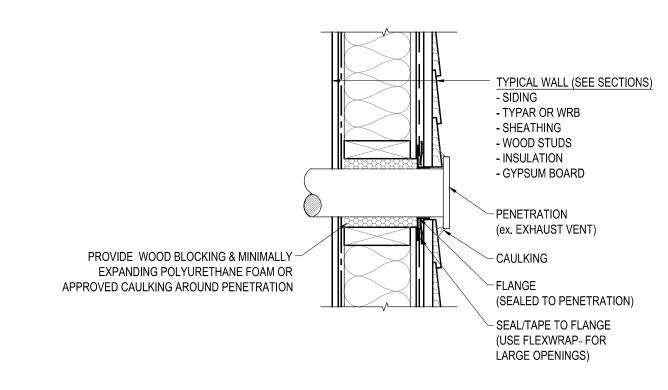


14 DETAIL - WALL PENETRATION

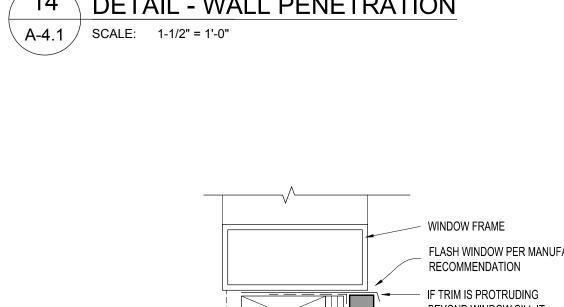


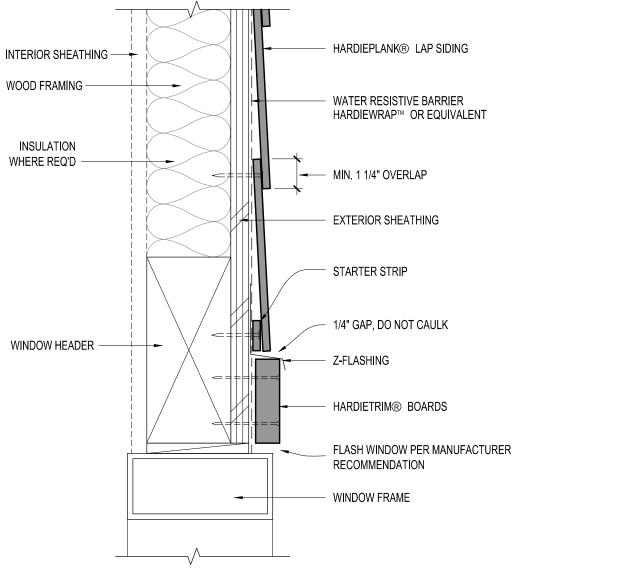


DETAIL - SIDING WINDOW / DOOR HEAD A-4.1 SCALE: 3" = 1'-0"

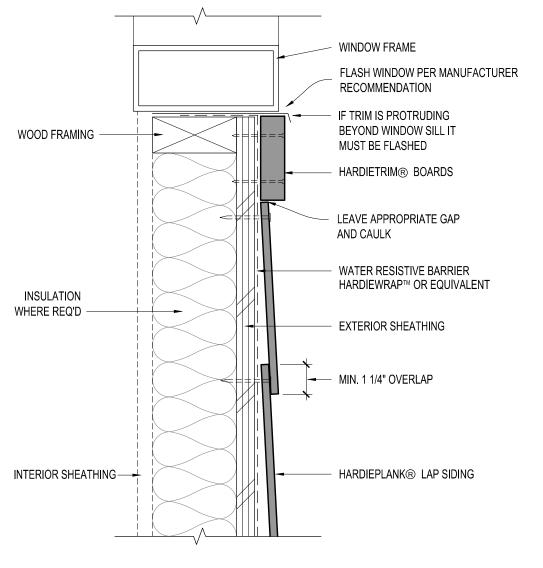

9 DETAIL - SIDING WINDOW / DOOR SILL A-4.1 | SCALE: 3" = 1'-0"

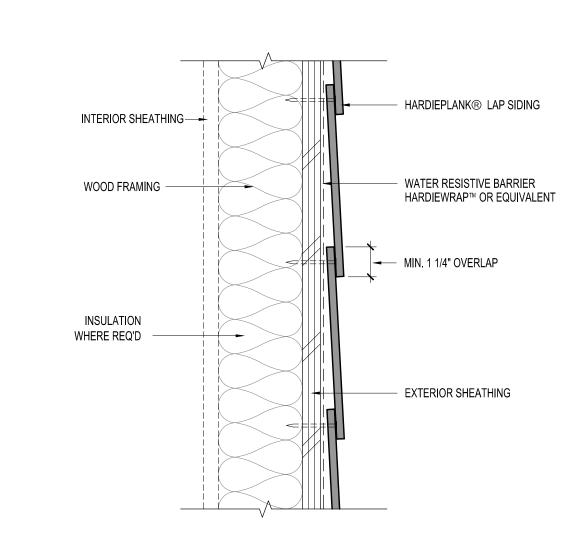



DETAIL - SIDING TYPICAL WALL A-4.1 / SCALE: 3" = 1'-0"

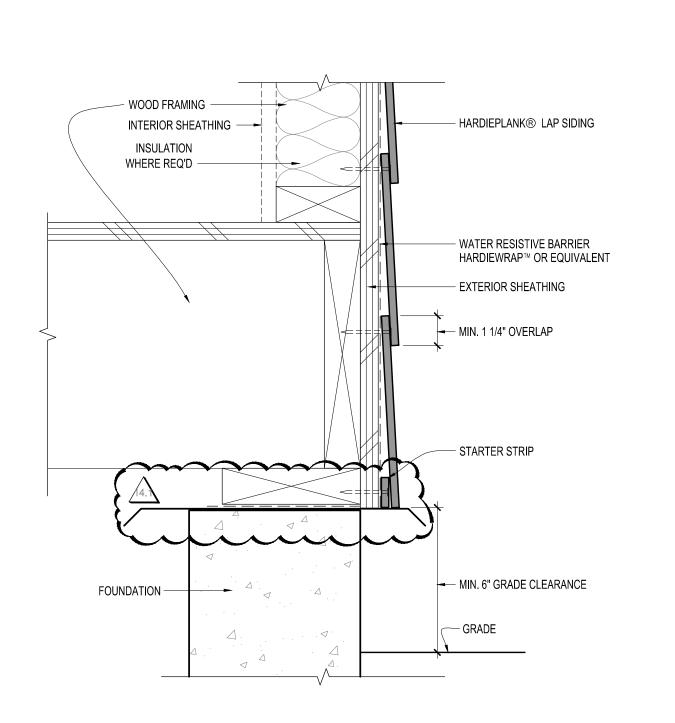


DETAIL - SIDING AT GRADE

A-4.3 / SCALE: 3" = 1'-0"

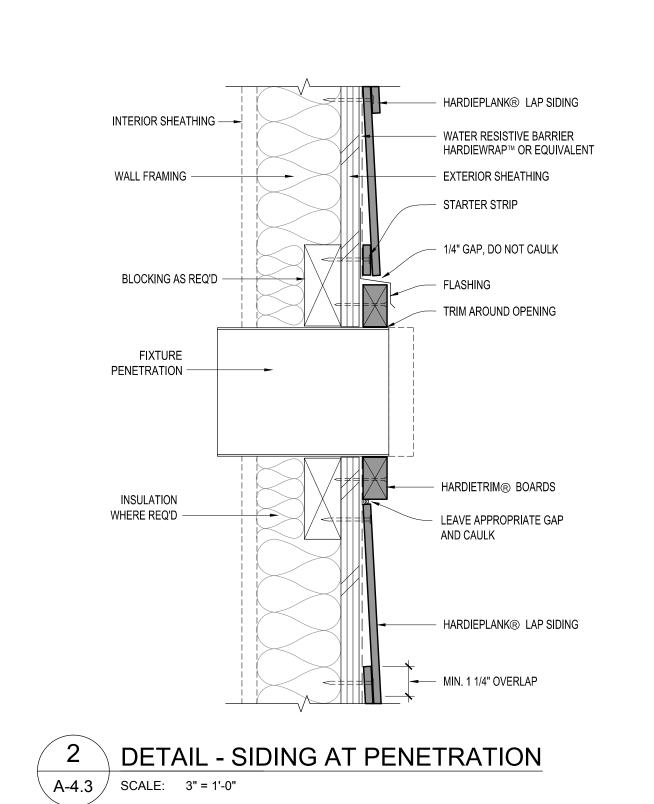


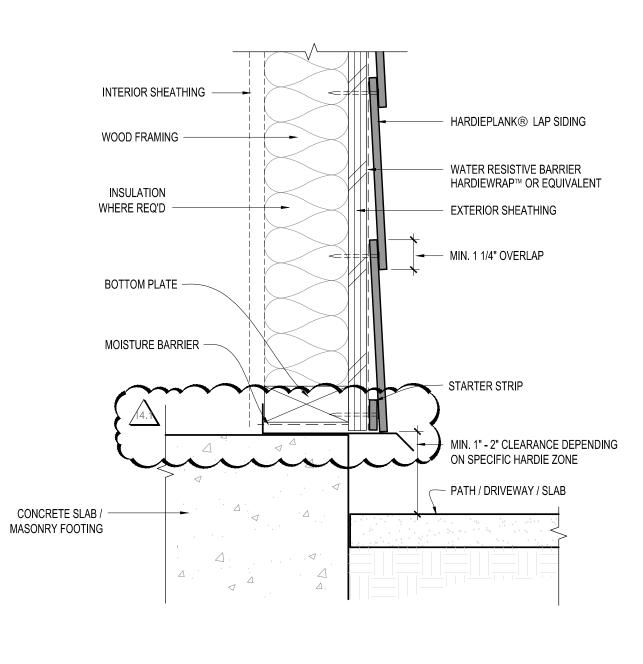



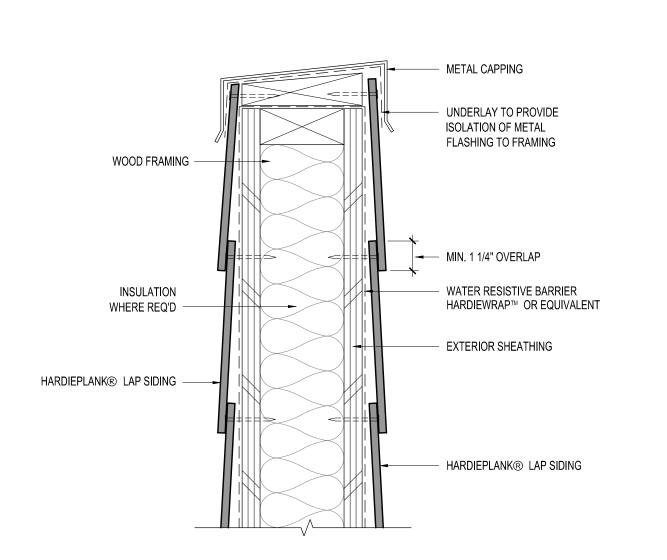

4 DETAIL - SIDING AT PARAPET WALL A-4.3 SCALE: 3" = 1'-0"

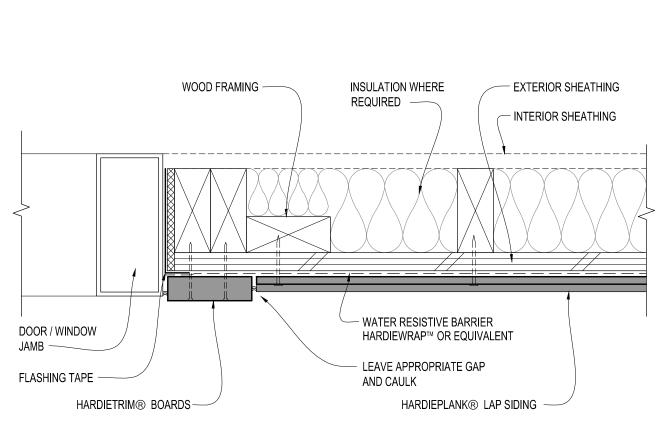

DETAIL - SIDING AT WINDOW / DOOR JAMB A-4.3 SCALE: 3" = 1'-0"




**BILLINGSLEY FACILITY BUILDING 4** 11,100 BILLINGSLEY ROAD WALDORF, MARYLAND 220602

Recovery Centers of America




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Alteration Remodel New Addition
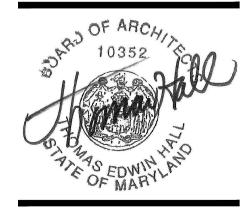
### New Construction **Drawing Status**

Design Phase Not For Construction

For Pricing For Permit Revision
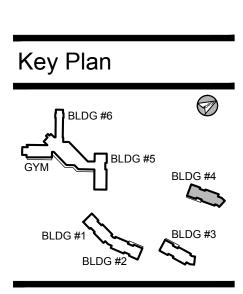
# For Construction


Revisions No. Date 06/03/2016 REVISION #10 07/07/2016 REVISION #11 07/27/2016 REVISION #12 09/16/2016 REVISION #13 01/06/2017 REVISION #14 02/03/2017 ADDENDUM #1

#### Job No: 6142.00 Drawn By: Checked By: TEH 17 FEB 03 AS NOTED Scale:


Drawing Title: HARDIPLANK

**DETAILS** Sheet No:

1 SECTION DETAIL - TYPICAL FOLDING PARTITION
A-4.2 SCALE: 1 1/2" = 1'-0"

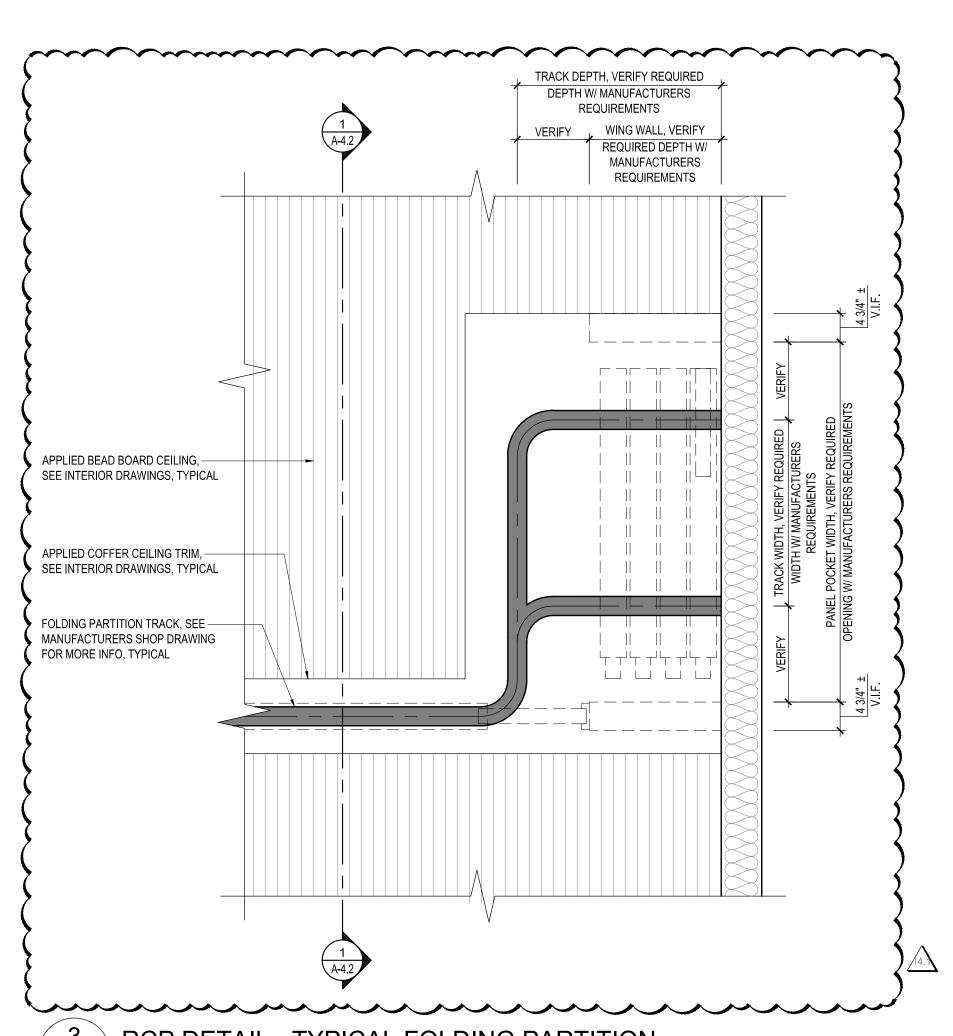

3 RCP DETAIL - TYPICAL FOLDING PARTITION
SCALE: 3/4" = 1'-0"

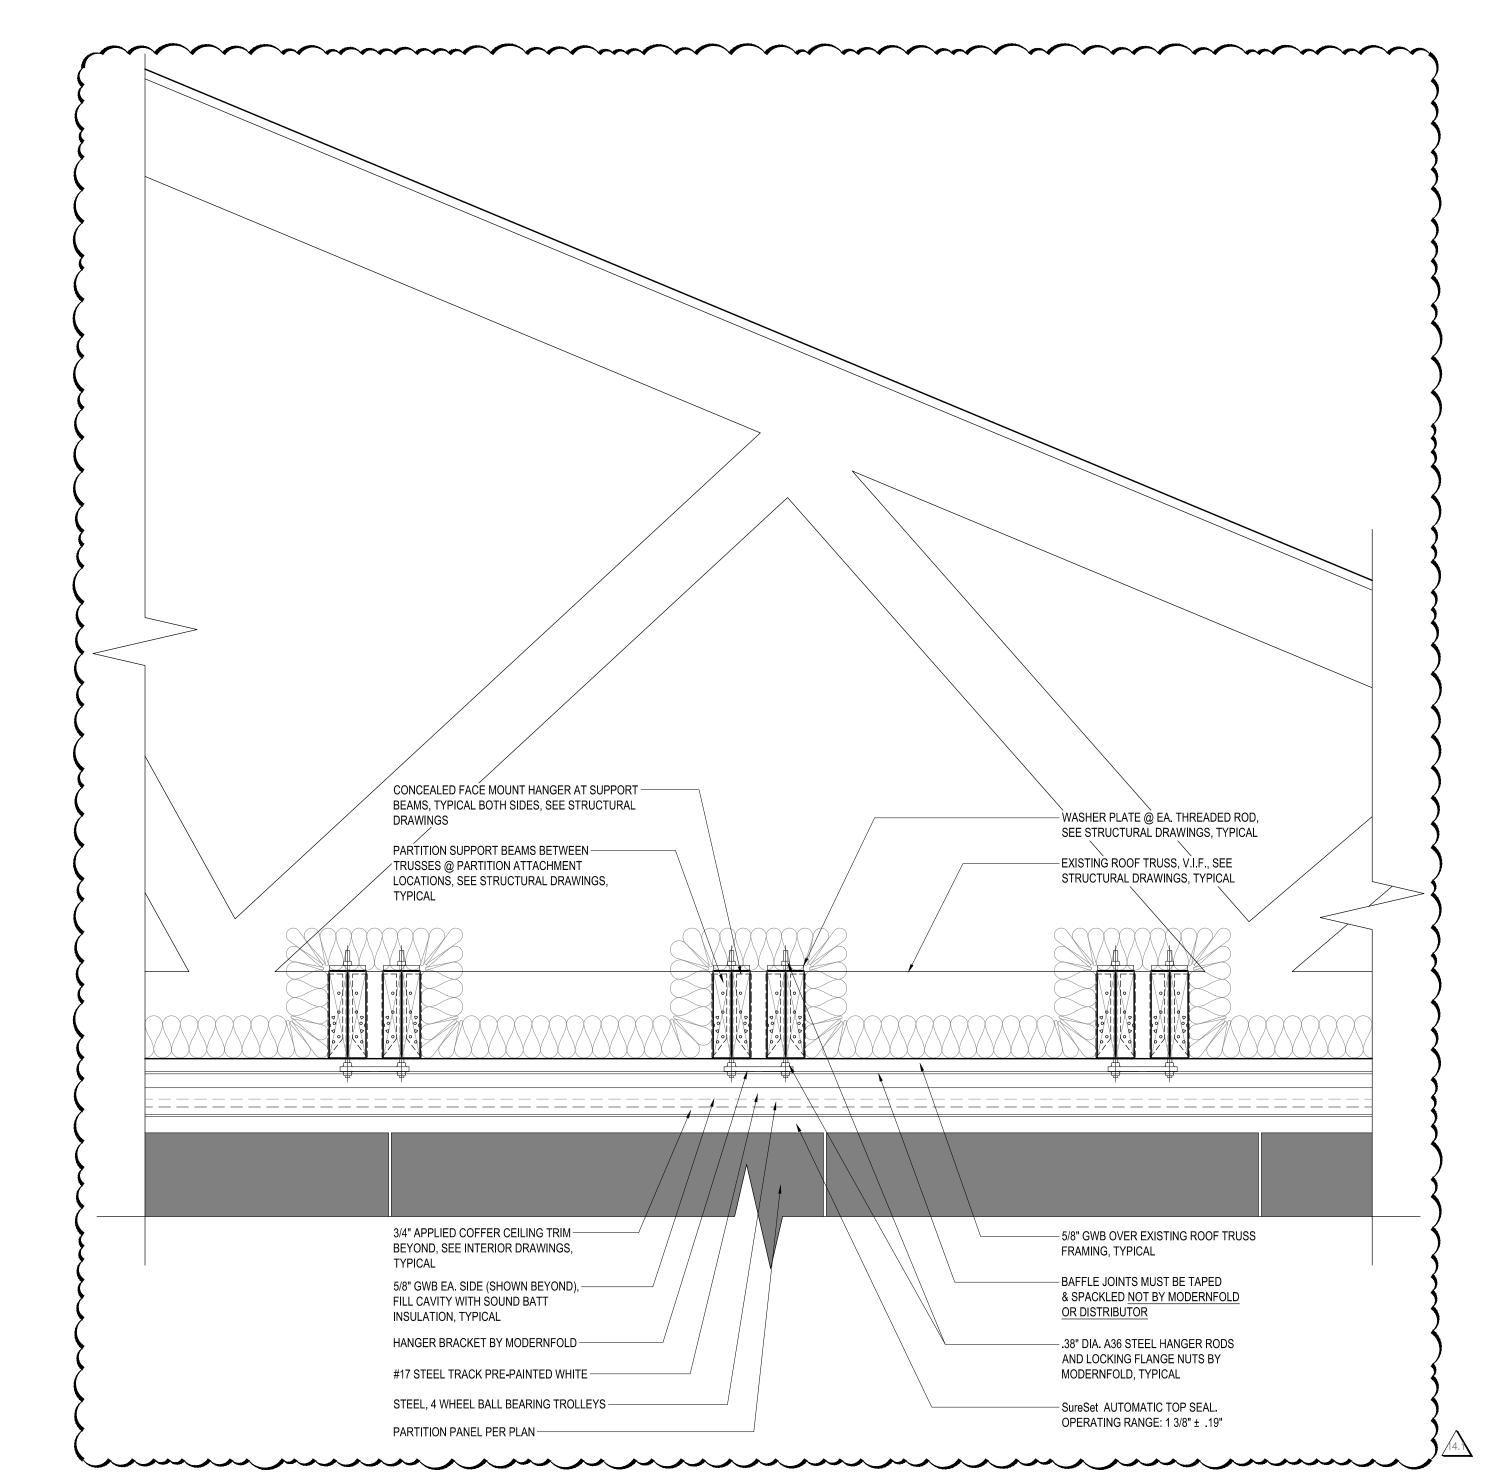

2 SECTION DETAIL - TYPICAL FOLDING PARTITION

A-4.2 SCALE: 1 1/2" = 1'-0"

R C A A Recovery Centers of America

Duois et

BILLINGSLEY
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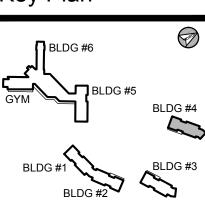
Sea



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Key Plan



Project Type

Alteration

Remodel

New Addition

New Construction

Drawing Status

Design Phase

Not For ConstructionFor PricingFor Permit

Revision
For Construction

Revisions

No. Date Description

06/03/2016 REVISION #10

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01/06/2017 REVISION #14

02/03/2017 ADDENDUM #1


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Drawn By:

Checked By: TEH


Checked By: TEH
Date: 17 FEB 03
Scale: AS NOTED
Drawing Title:

DETAILS

Sheet No:
A-4.2

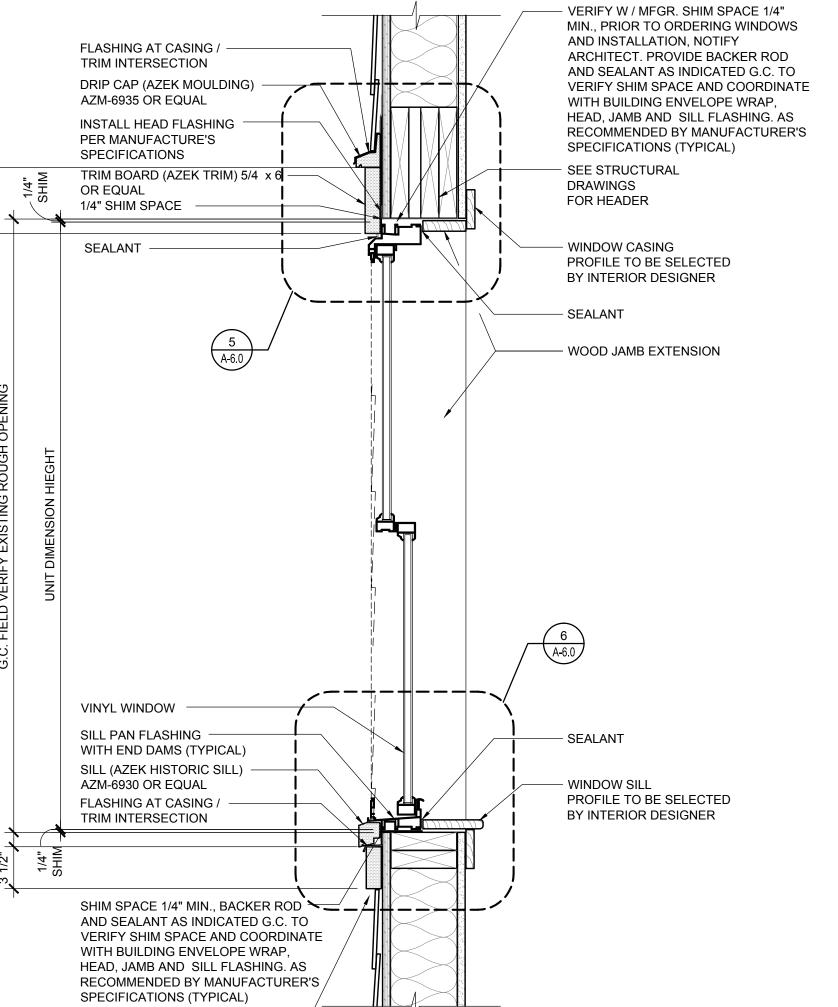

#### **A-6.0** Scale: 1 1/2" = 1'-0" BY OWNER WOOD JAMB EXTENSION — - ANCHOR / REINFORCE WINDOWS PER MANUFACTURER SPECIFICATIONS TYPICAL - SEALANT -TRIM BOARD -(AZEK TRIM) 5 /4 x 4 — FLASHING (TYPICAL) OR EQUAL - VERIFY W / MFGR. SHIM SPACE 1/4" SEALANT MIN., PRIOR TO ORDERING WINDOWS UNIT DIMENSION WIDTH AND INSTALLATION, NOTIFY ARCHITECT. PROVIDE BACKER ROD ∼1/4" AND SEALANT AS INDICATED G.C. TO MINIMUM ROUGH OPENING WITH BUILDING ENVELOPE WRAP, 2 HORIZONTAL SECTION (JAMB) HEAD, JAMB AND SILL FLASHING. AS A-6.0 Scale: 1 1/2" = 1'-0" SPECIFICATIONS (TYPICAL)

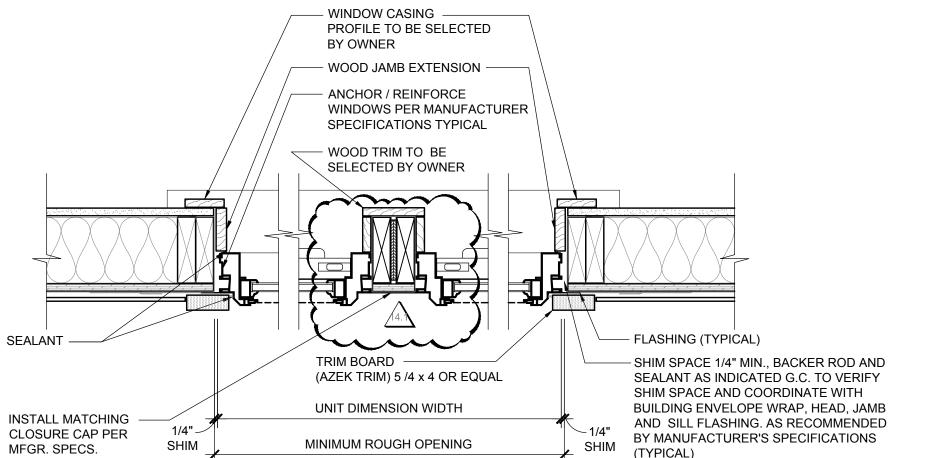

HORIZONTAL SECTION (JAMB @ DOUBLE WINDOW)



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— VERIFY W / MFGR. SHIM SPACE

PROVIDE BACKER ROD AND

BUILDING ENVELOPE WRAP,

SPECIFICATIONS (TYPICAL)

FLASHING. AS RECOMMENDED

VERIFY SHIM SPACE AND COORDINATE WITH

HEAD, JAMB AND SILL

BY MANUFACTURER'S

- VERIFY W / MFGR. SHIM

SPACE 1/4" MIN.,

WINDOWS AND

ARCHITECT.

FLASHING. AS RECOMMENDED BY

WINDOW NOTES

- VERIFY IN FIELD ALL ROUGH OPENINGS, SHIM SPACE

AND SILL TYPICAL, PRIOR TO ORDERING WINDOWS.

- PROVIDE CUSTOM JAMB EXTENSIONS AS REQUIRED.

- ALL DOUBLE HUNG WINDOWS 4" MAX. OPENINGS ,SDL,

- ALL EXISTING WINDOW SILLS AND HEAD HEIGHTS TO

VINYL ,FULL HEIGHT SCREENS AND INSULATED LOW-E

GLAZING. WHERE SILL IS BELOW 18" FROM THE FLOOR AND

- ALL DOUBLE HUNG AND FIXED WINDOWS MODELED AFTER

- ALL WINDOWS TO HAVE CONTINUOUS METAL FLASHING

- FIELD VERIFY ALL WINDOW / ENTRANCE OPENINGS PRIOR

- ALL GLAZING TO BE 1" INSULATED GLASS - ANY GLAZING

- ALL GLAZING AT DOORS, SIDE LIGHTS AND TRANSOMS TO

- NEW ALUMINUM DOORS REPLACING EXISTING DOORS -

- EXISTING WINDOW / ENTRANCE SYSTEMS TO REMAIN -

- VERIFY HARDWARE STYLE, COLOR, MATERIAL, WITH

CLEAN, REPAIR AND RESTORE TO GOOD WORKING ORDER. NOTIFY OWNER AND ARCHITECT IF REPLACEMENT IS

KEEP SWINGS OUTWARD IN SAME DIRECTION AS

ADJACENT TO DOORS TEMPERED GLASS MUST BE USED.

- PROVIDE INTERIOR TRIM PROFILES AS

REMAIN. EXCEPT WHERE NOTED.

ALL STOREFRONT WINDOWS

AT HEAD, SILL, AND JAMBS.

BE TEMPERED GLASS.

OWNER PRIOR TO ORDERING.

REQUIRED.

TO FABRICATION OF WINDOW FRAMES.

EXTENDING BELOW 18" TO BE TEMPERED.

SELECTED BY OWNER.

INDICATED WITH MANUFACTURER SPECIFICATIONS AND

COORDINATE WITH FLASHING THICKNESS AT HEAD, JAMB,

MANUFACTURER'S

PRIOR TO ORDERING

INSTALLATION, NOTIFY

PROVIDE BACKER ROD AND SEALANT AS INDICATED G.C.

BUILDING ENVELOPE WRAP, HEAD, JAMB AND SILL

SPECIFICATIONS (TYPICAL)

TO VERIFY SHIM SPACE AND COORDINATE WITH

PRIOR TO ORDERING WINDOWS AND INSTALLATION, NOTIFY

SEALANT AS INDICATED G.C. TO

1/4" MIN.,

-SEALANT

VERTICAL SECTION (HEAD)

6 VERTICAL SECTION (SILL)

E = EXISTING ROUGH OPENING N = NEW ROUGH OPENING

**A-6.0** Scale: 3" = 1'-0"

A-6.0 Scale: 3" = 1'-0"

ARCHITECT.

BUILDING ENVELOPE

INSTALL HEAD FLASHING

PER MANUFACTURE'S

SPECIFICATIONS

SILL PAN FLASHING


FLASHING AT CASING /

BUILDING ENVELOPE

TRIM INTERSECTION


WITH END DAMS

(TYPICAL)

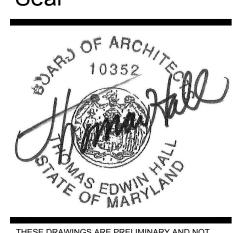

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Project Type

Alteration Remodel
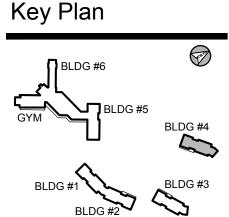
> New Addition New Construction

**Drawing Status** 

Design Phase

Not For Construction For Pricing

For Permit Revision

For Construction

Revisions

No. Date 06/03/2016 REVISION #10 07/07/2016 REVISION #11 07/27/2016 REVISION #12

09/16/2016 REVISION #13 01/06/2017 REVISION #14 4. 02/03/2017 ADDENDUM #1

Job No: 6142.00 Drawn By: Checked By: TEH


17 FEB 03 AS NOTED Scale: Drawing Title:

WINDOW SCHEDULES

Sheet No:

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BILLINGSLEY BUILDING 4

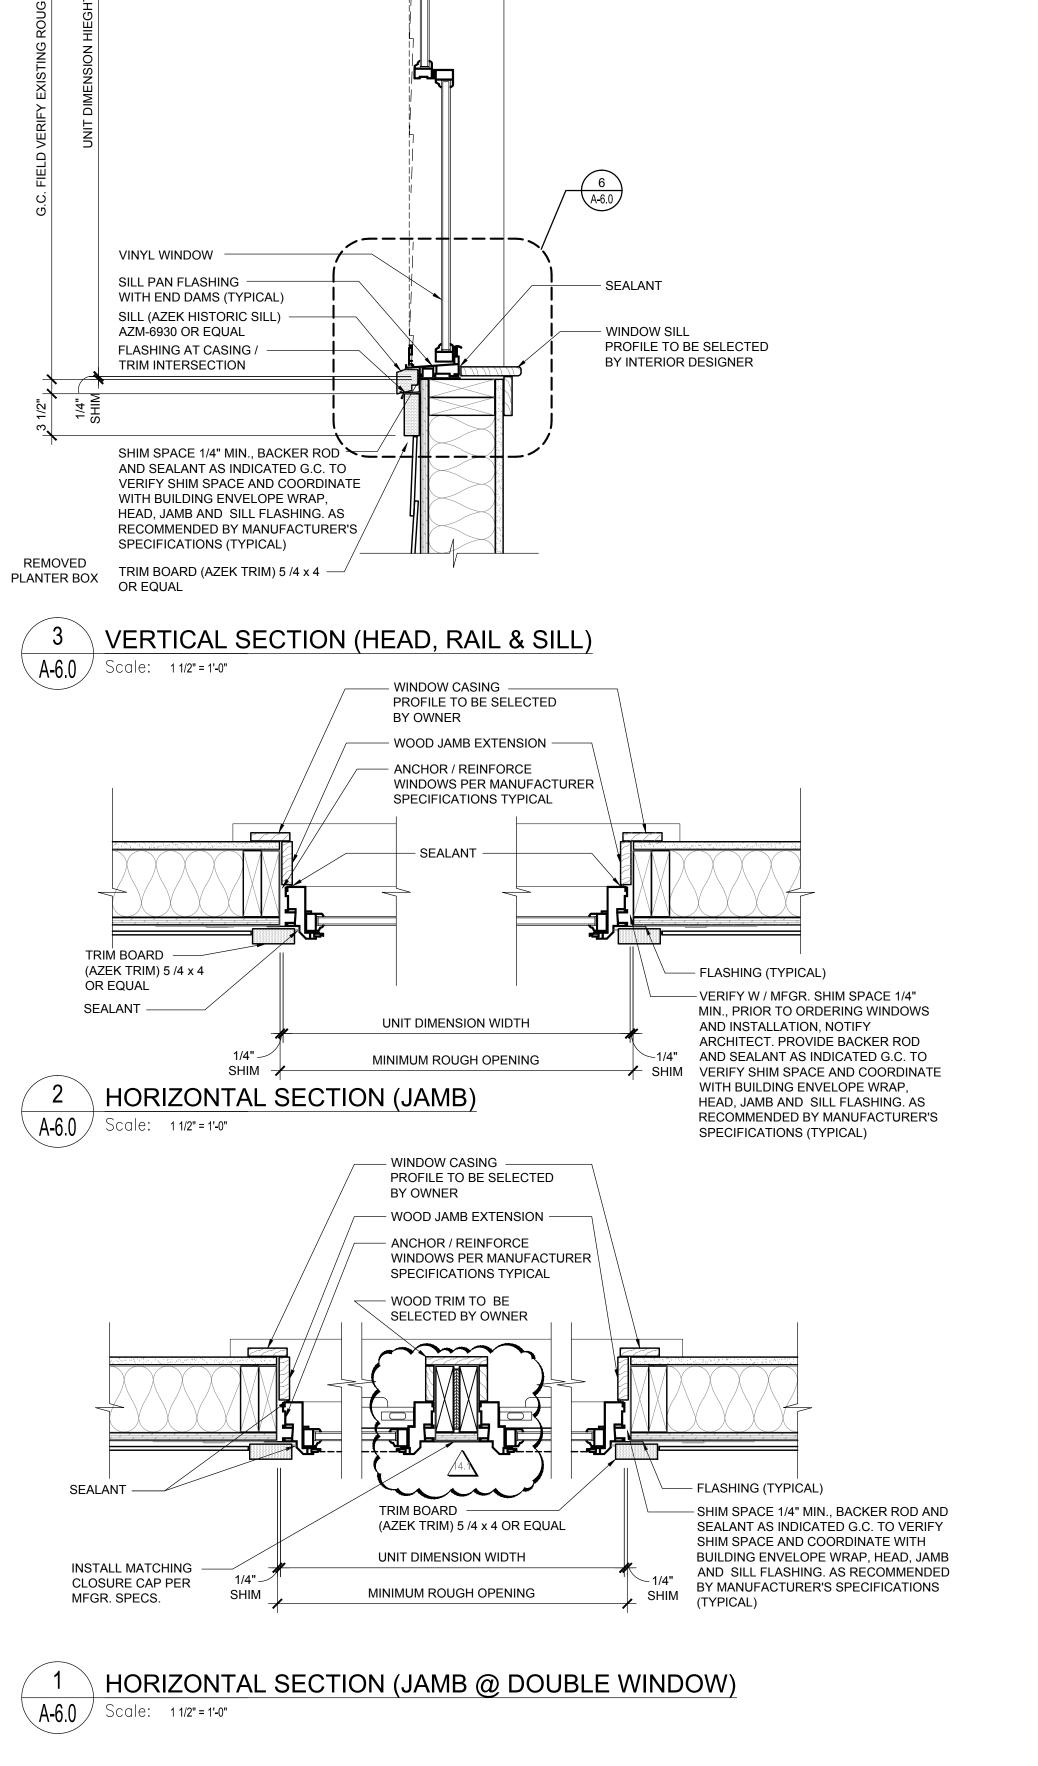

|                 |                        |                    | RLD(               | 7 4 - D | JUUK     | <b>OCHE</b>    | DULE   | : - FIK  | ST FL      | UUK      |              |                |                                                                                     |  |
|-----------------|------------------------|--------------------|--------------------|---------|----------|----------------|--------|----------|------------|----------|--------------|----------------|-------------------------------------------------------------------------------------|--|
| DOOR<br>NO.     | ROOM NAME              | WIDTH              | HEIGHT             | THICK   | MAT.     | DOOR<br>FINISH | ТҮРЕ   | MAT.     | FRAME      | TYPE     | HDWR         | FIRE<br>RATING | REMARKS                                                                             |  |
| 1-100           | LOUNGE                 | (2) 3'-0"          | 7'-0"              | 1-3/4"  | AL/GL    | PTD            | F      | AL       | PTD        | 02       | 1.0          |                | EXTERIOR DR, SEE NOTE 23 / SM CLOSER /                                              |  |
|                 |                        |                    |                    |         |          |                |        |          |            |          |              |                | FINISH: BLACK ANODIZED ALUMINUM FOLDING PARTITION SUBMIT SHOP                       |  |
| 1-100.1         |                        |                    |                    |         |          |                |        |          |            |          |              |                | DRAWING                                                                             |  |
| 1-101           | LOUNGE / GROUP ROOM    | 3'-0"              | 7'-0"              | 1-3/4"  | AL/GL    | PTD            | E      | AL       | PTD        | 01       | 2.0          |                | EXTERIOR DR, SEE NOTE 23 /<br>SM CLOSER / FINISH: BLACK ANODIZED<br>ALUMINUM        |  |
| 1-102           | GROUP ROOM             | 3'-0"              | 7'-0"              | 1-3/4"  | WD/GL    | PTD            | N      | НМ       | PTD        | 15       | 12.0         | 20 MIN         | SURFACE MOUNTED CLOSER                                                              |  |
| 1-103           | ROOM                   | 3'-0"              | 7'-0"              | 1-3/4"  | WD       | PTD            | М      | НМ       | PTD        | 15       | 10.0         | 20 MIN         | SURFACE MOUNTED CLOSER                                                              |  |
| 1-104           | LAUNDRY RM.            | (2) 2'-6"          | 7'-0"              | 1-3/4"  | WD       | PTD            | TT     | НМ       | PTD        | 16       | 11.0         |                | 180° HINGE                                                                          |  |
| 1-104.1         | LAUNDRY RM.            | (2) 2'-6"          | 7'-0"              | 1-3/4"  | WD       | PTD            | TT     | HM       | PTD        | 16       | 11.0         |                | 180° HINGE                                                                          |  |
| 1-105           | BEDROOM (2)            | 3'-0"              | 7'-0"              | 1-3/4"  | WD       | PTD            | М      | НМ       | PTD        | 15       | 14.0         | 20 MIN         | CLOSER SEE HARDWARE SET                                                             |  |
| 1-105A          | TOILET RM.             | 3'-0"              | 7'-0"              | 1-3/4"  | WD       | PTD            | М      | НМ       | PTD        | 14       | 15.0         |                | PROVIDE EMERGENCY PIN / KEY FOR STAFF<br>ENTRY                                      |  |
| 1-106           | BEDROOM (2)            | 3'-0"              | 7'-0"              | 1-3/4"  | WD       | PTD            | М      | НМ       | PTD        | 15       | 14.0         | 20 MIN         | CLOSER SEE HARDWARE SET                                                             |  |
| 1-106A          | TOILET RM.             | 3'-0"              | 7'-0"              | 1-3/4"  | WD       | PTD            | М      | HM       | PTD        | 14       | 15.0         |                | PROVIDE EMERGENCY PIN / KEY FOR STAFF                                               |  |
|                 |                        |                    |                    |         |          |                |        |          |            |          |              | 00 1411        | ENTRY                                                                               |  |
| 1-107<br>1-107A | BEDROOM (2) TOILET RM. | 3'-0"              | 7'-0"<br>7'-0"     | 1-3/4"  | WD<br>WD | PTD<br>PTD     | M<br>M | HM<br>HM | PTD<br>PTD | 15<br>14 | 14.0<br>15.0 | 20 MIN         | CLOSER SEE HARDWARE SET  PROVIDE EMERGENCY PIN / KEY FOR STAFF ENTRY                |  |
| 1-108           | OFFICE                 | 3'-0"              | 7'-0"              | 1-3/4"  | WD       | PTD            | М      | НМ       | PTD        | 15       | 10.0         | 20 MIN         | SURFACE MOUNTED CLOSER                                                              |  |
| 1-109           | EXIST, MECH, RM,       | 2'-10"+/- (V.I.F.) | 6'-8" +/- (V.I.F.) | 1-3/4"  | MTL HM-1 | PTD            | С      | НМ       | PTD        | 01       | 5.0          |                | EXTERIOR DOOR, SEE NOTE 23 / SM<br>CLOSER                                           |  |
| 1-110           | TRASH                  | 3'-0"              | 7'-0"              | 1-3/4"  | MTL      | PTD            | S      | НМ       | PTD        | 12       | 12.0         | 1 HOUR         | SURFACE MOUNTED CLOSER                                                              |  |
| 1-110A          | TRASH                  | (2) 3'-0"          | 7'-0"              | 1-3/4"  | MTL HM-I | PTD            | D      | НМ       | PTD        | 02       | 4.0          |                | EXTERIOR DOOR, SEE NOTE 23 / SM<br>CLOSER                                           |  |
| 1-111           | EXIST. SPRINKLER RM.   | 2'-10"+/- (V.I.F.) | 6'-8" +/- (V.I.F.) | 1-3/4"  | MTL      | PTD            | С      | НМ       | PTD        | 01       | 5.0          |                | EXTERIOR DOOR, SEE NOTE 23 / SM<br>CLOSER                                           |  |
| 1-112           | JAN. CL.               | 3'-0"              | 7'-0"              | 1-3/4"  | WD       | PTD            | М      | НМ       | PTD        | 15       | 9.0          | 1 HOUR         | SURFACE MOUNTED CLOSER                                                              |  |
| 1-113           | IT CL.                 | 2'-8"              | 7'-0"              | 1-3/4"  | WD       | PTD            | М      | НМ       | PTD        | 15       | 9.0          | 1 HOUR         | SURFACE MOUNTED CLOSER                                                              |  |
| 1-114           | OFFICE                 | 3'-0"              | 7'-0"              | 1-3/4"  | WD       | PTD            | М      | HM       | PTD        | 15       | 7.0          | 1 HOUR         | SURFACE MOUNTED CLOSER                                                              |  |
| 1-115           | SOILED LINEN CLOSET    | 3'-0"              | 7'-0"              | 1-3/4"  | WD       | PTD            | М      | НМ       | PTD        | 15       | 9.0          | 1 HOUR         | SURFACE MOUNTED CLOSER                                                              |  |
| 1-116           | CLEAN LINEN CLOSET     | 3'-0"              | 7'-0"              | 1-3/4"  | WD       | PTD            | М      | HM       | PTD        | 15       | 8.0          |                | SURFACE MOUNTED CLOSER                                                              |  |
| 1-117           | BEDROOM (2)            | 3'-0"              | 7'-0"              | 1-3/4"  | WD       | PTD            | М      | HM       | PTD        | 15       | 14.0         | 20 MIN         | CLOSER SEE HARDWARE SET                                                             |  |
| 1-117A          | TOILET RM.             | 3'-0"              | 7'-0"              | 1-3/4"  | WD       | PTD            | М      | НМ       | PTD        | 14       | 15.0         |                | PROVIDE EMERGENCY PIN / KEY FOR STAFF ENTRY                                         |  |
| 1-118           | BEDROOM (2)            | 3'-0"              | 7'-0"              | 1-3/4"  | WD       | PTD            | М      | НМ       | PTD        | 15       | 14.0         | 20 MIN         | CLOSER SEE HARDWARE SET                                                             |  |
| 1-118A          | TOILET RM.             | 3'-0"              | 7'-0"              | 1-3/4"  | WD       | PTD            | М      | НМ       | PTD        | 14       | 15.0         |                | PROVIDE EMERGENCY PIN / KEY FOR STAFF                                               |  |
| 1-119           | BEDROOM (2)            | 3'-0"              | 7'-0"              | 1-3/4"  | WD       | PTD            | M M    | HM       | PTD        | 15       | 14.0         | 20 MIN         | ENTRY CLOSER SEE HARDWARE SET                                                       |  |
|                 | · ,                    |                    |                    |         |          |                |        |          |            |          |              | 20 1/1111      | PROVIDE EMERGENCY PIN / KEY FOR STAFF                                               |  |
| 1-119A          | TOILET RM.             | 3'-0"              | 7'-0"              | 1-3/4"  | WD       | PTD            | М      | НМ       | PTD        | 14       | 15.0         |                | ENTRY                                                                               |  |
| 1-120           | BEDROOM (2)            | 3'-0"              | 7'-0"              | 1-3/4"  | WD       | PTD            | М      | HM       | PTD        | 15       | 14.0         | 20 MIN         | CLOSER SEE HARDWARE SET                                                             |  |
| 1 <b>-</b> 120A | TOILET RM.             | 3'-0"              | 7'-0"              | 1-3/4"  | WD       | PTD            | М      | HM       | PTD        | 14       | 15.0         |                | PROVIDE EMERGENCY PIN / KEY FOR STAFF<br>ENTRY                                      |  |
| 1-121           | OFFICE                 | 3'-0"              | 7'-0"              | 1-3/4"  | WD       | PTD            | М      | НМ       | PTD        | 15       | 10.0         | 20 MIN         | SURFACE MOUNTED CLOSER                                                              |  |
| 1-122           | ROOM                   | 3'-0"              | 7'-0"              | 1-3/4"  | WD       | PTD            | М      | НМ       | PTD        | 15       | 10.0         | 20 MIN         | SURFACE MOUNTED CLOSER                                                              |  |
| 1-123           | WORK STATION           | N/A                | N/A                | N/A     | N/A      | N/A            | N/A    | N/A      | N/A        | N/A      | N/A          |                |                                                                                     |  |
| 1-124           | CLOSET                 | 2'-0"              | 7'-0"              | 1-3/4"  | WD       | PTD            | М      | НМ       | PTD        | 15       | 8.0          |                |                                                                                     |  |
| 1-125           | TOILET RM.             | 3'-0"              | 7'-0"              | 1-3/4"  | WD       | PTD            | М      | HM       | PTD        | 15       | 13.0         | 20 MIN         | SURFACE MOUNTED CLOSER                                                              |  |
| 1-126           | BEDROOM (2)            | 3'-0"              | 7'-0"              | 1-3/4"  | WD       | PTD            | M      | HM       | PTD        | 15       | 14.0         | 20 MIN         | CLOSER SEE HARDWARE SET                                                             |  |
| 1-126A          | TOILET RM.             | 3'-0"              | 7'-0"              | 1-3/4"  | WD       | PTD            | М      | НМ       | PTD        | 14       | 15.0         |                | PROVIDE EMERGENCY PIN / KEY FOR STAFF<br>ENTRY                                      |  |
| 1-127           | BEDROOM (2)            | 3'-0"              | 7'-0"              | 1-3/4"  | WD       | PTD            | М      | НМ       | PTD        | 15       | 14.0         | 20 MIN         | CLOSER SEE HARDWARE SET                                                             |  |
| 1-127A          | TOILET RM.             | 3'-0"              | 7'-0"              | 1-3/4"  | WD       | PTD            | М      | НМ       | PTD        | 14       | 15.0         |                | PROVIDE EMERGENCY PIN / KEY FOR STAFF<br>ENTRY                                      |  |
| 1-128           | BEDROOM (2) "FA"       | 3'-0"              | 7'-0"              | 1-3/4"  | WD       | PTD            | M      | HM       | PTD        | 15       | 14.0         | 20 MIN         | CLOSER SEE HARDWARE SET                                                             |  |
| 1-128A          | TOILET RM.             | 3'-0"              | 7'-0"              | 1-3/4"  | WD       | PTD            | M      | HM       | PTD        | 14       | 15.0         |                | PROVIDE EMERGENCY PIN / KEY FOR STAFF<br>ENTRY                                      |  |
| 1-129           | CORRIDOR               | 3'-0"              | 7'-0"              | 1-3/4"  | AL/GL    | PTD            | E      | AL       | PTD        | 01       | 3.0          |                | EXTERIOR DOOR, SEE NOTE 23 / SM<br>CLOSER / FINISH: BLACK ANODIZED<br>ALUMINUM      |  |
| 1-130           | CORRIDOR               | 3'-0"              | 7'-0"              | 1-3/4"  | AL/GL    | PTD            | E      | AL       | PTD        | 01       | 3.0          |                | EXTERIOR DOOR, SEE NOTE 23 / SM<br>CLOSER / FINISH: BLACK ANODIZED<br>ALUMINUM      |  |
| 1-130A          | CORRIDOR               | (2) 2'-10"         | 7'-0"              | 1-3/4"  | WD/GL    | PTD            | U      | НМ       | PTD        | 17       | 6.0          | 1 HOUR         | "SMOKE BARRIER" - OPPOSING SWING, RT<br>DOOR, HOLD OPEN, CLOSER SEE<br>HARDWARE SET |  |
| A-100           | ATTIC ACCESS DOOR      | 3-0" +/- (V.I.F.)  | 5'-0" +/- (V.I.F.) | 1-3/4"  | MTL HM-I | PTD            | С      | НМ       | PTD        | 01       | 3.1          |                | EXTERIOR DOOR, SURFACE MOUNTED CLOSER / GC TO VERIFY EXISTING OPENING               |  |

#### **GENERAL DOOR NOTES** SEE FLOOR PLAN TO CONFIRM DOOR SWING ALL DOORS ARE KEYED TO BE INDIVIDUALLY KEYED ON A SINGLE MASTER KEY AND KEYED TO MATCH BUILDING MASTER KEY SYSTEM. ALL CORES TO BE REMOVEABLE. ALL DOOR CLOSURES ARE TO BE ADA, ANSI A117.1 COMPLAINT WITH CLOSING SPECIFICATIONS AS FOLLOWS: 2.1. FROM AN OPEN POSITION OF 70 DEGREES, IT WILL TAKE 3 SECONDS TO MOVE TO A POINT 3" FROM THE LATCH. 2.2. MAXIMUM OPENING FORCE OF 5 LBS ALL DOORS MUST HAVE SILENCERS ALL NEW LEVER HARDWARE TO BE ADA COMPLIANT ALL NEW HM INTERIOR DOOR FRAME TO BE KD HOLLOW METAL FRAMES. COORDINATE DOOR TRIM WITH WALL WIDTH ON WHICH IT APPEARS ALL NEW EMERGENCY RELEASE STOP ACCESS DOOR FRAMES TO BE COORDINATED WITH WALL WIDTH ON WHICH IT APPEARS ALL PATIENT TOILET ROOMS TO HAVE EMERGENCY RELEASE STOP, THERMAL FUSED DOORS, CONTINUOUS SWING CLEAR PROVIDE FLOOR DOOR STOPS WHERE DOOR STOPS AT ALL DOORS AS REQUIRED ALL INTERIOR HARDWARE AND HINGES TO BE BRIGHT CHROMIUM PLATED (US26) 10. ALL NEW BUTT HINGES TO BE HEAVY DUTY SECURITY AND KEYING TO BE COORDINATED WITH BUILDING OWNER, SECURITY VENDOR AND DOOR HARDWARE PROVIDER PRIOR TO ORDERING 12. THE SECURITY SYSTEM NEEDS TO BE TIED INTO THE FIRE ALARM SYSTEM AND BE "FAIL SECURE" 13. PROVIDE "SOUND TRANSMISSION" CONTROL WITH ALL APPROPRIATE SEALS AND THRESHOLDS ON ALL INTERIOR 14. PROVIDE INTEGRATED WEATHER STRIPING AS REQUIRED FOR ALL EXTERIOR DOORS PROVIDE "MICRO SHIELD" A BACTERIA, MOLD, MILDEW, ALGAE AND OTHER MICROBES INHIBITOR OR APPROVED EQUAL 16. PROVIDE CONCEALED CLOSERS WHERE NOTED ALL OTHER CLOSERS TO BE SURFACE MOUNTED OR SPRING PROVIDE INTEGRATED "WIEGAND" ACCESS CONTROL LOCKS ON ALL DOORS TO BE CONTROLED BY STAFF. COORDINATE WITH SECURITY VENDOR, BUILDING OWNER AND ENGINEERS PRIOR TO ORDERING 18. PROVIDE FLUSH KD FRAMES WITH WOOD TRIM ON DOORS NOTED IN DOOR SCHEDULE. SEE ID DRAWINGS DOOR DETAILS 19. COORDINATE WITH OWNER SECURITY VENDOR ALL DOORS TO **BE ALARMED** 20. EXTERIOR DOOR PULLS TO BE BLACK ANODIZED ALUMINUM 21. ALL TOILET ROOM DOORS TO HAVE AN EMERGENCY PIN/KEY FOR STAFF ACCESS 22. ALL DOOR PULLS / HANDELS TO BE ADA COMPLIANT RATED DOOR NOTES BEDROOM & GENERAL DOOR ASSEMBLY LOCATED IN A "1/2 OR 1 HOUR" RATED WALL ASSEMBLY TO BE 20 MINUTE RATED ALL OTHER DOOR ASSEMBLY LOCATED IN A "1 HOUR" RATED WALL ASSEMBLY TO BE 1 HOUR RATED. IE: IT CLOSETS, JC CLOSETS, SOILED LINEN CLOSETS, STORAGE ROOMS, ELECTRIC CLOSETS/ROOMS, MECHANICAL ROOMS, ETC.

**DOOR TYPE V**PAINT GRADE, SOLID

WOOD TWO PANEL,

WHITE PRIMED SHAKER

DOOR

<u>DOOR TYPE U</u> PAINT GRADE, SOLID WOOD,

WHITE PRIMED W/ 1 HOUR FIRE

RATING W/ FIRE GLASS VISION

PANEL GLAZING: 9/16" LAMI (.060

SGP INTERLAYER)

RATED GLASS,


**FRAME TYPE 17** 

OPPOSING SWING DOORS

FRAME FLUSH KD HM FRAME

TO RECEIVE WOOD

ACCENT TRIM

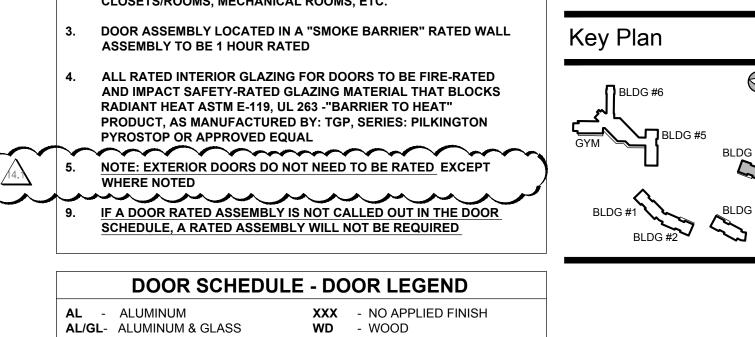

Recovery Centers of America

**BILLINGSLEY** 

**FACILITY** 

**BUILDING 4** 

11,100 BILLINGSLEY

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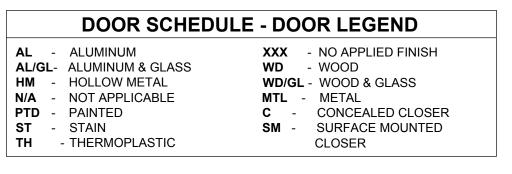
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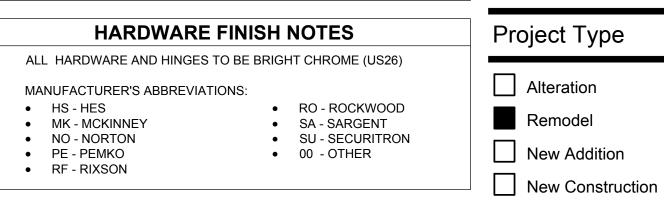
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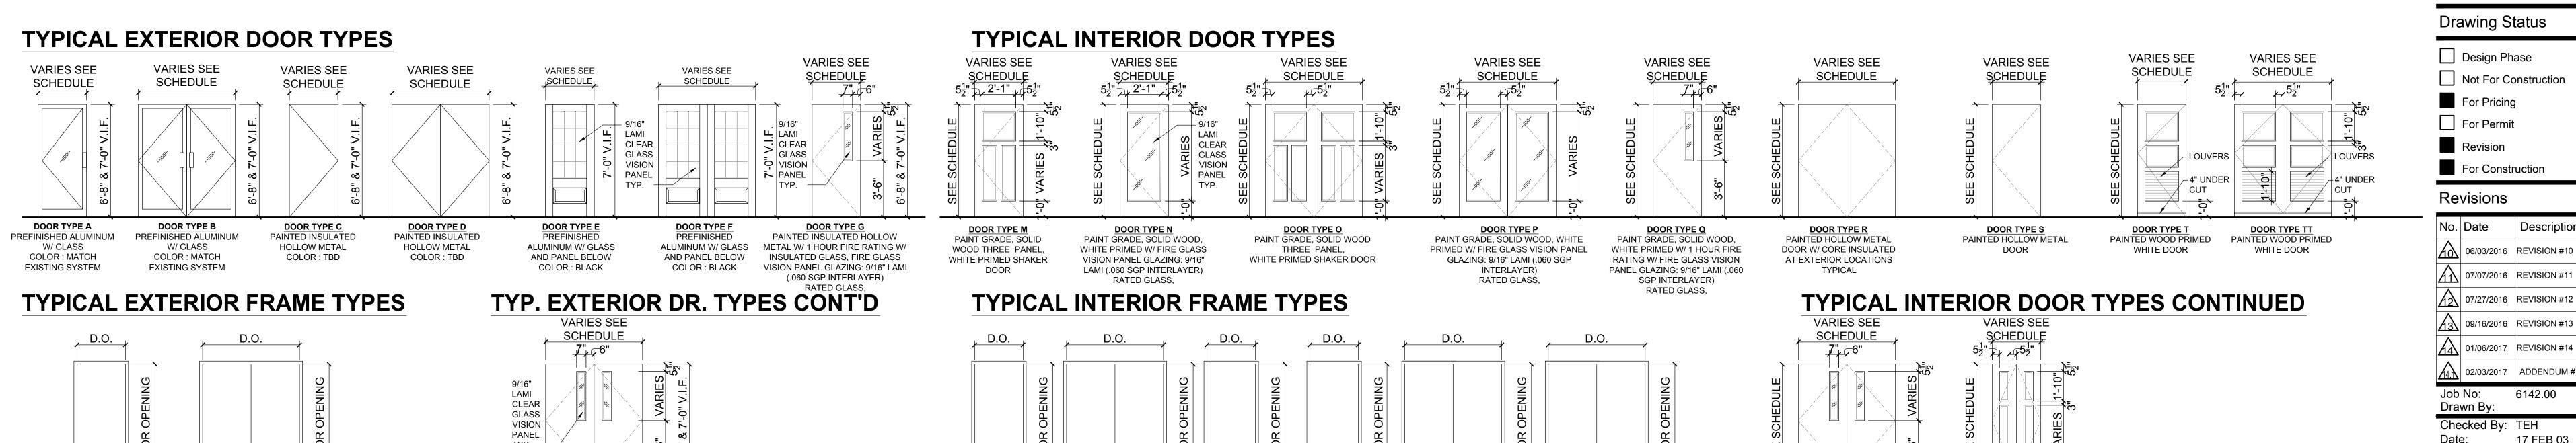
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ROAD WALDORF,







EMERGENCY

ACCENT TRIM

STOP RELEASE HM FRAME TO RECEIVE WOOD

FLUSH TO RECEIVE WOOD ACCENT TRIM

FRAME TYPE 15

FLUSH KD HM FRAME

TO RECEIVE WOOD

ACCENT TRIM

FLUSH KD HM FRAME

FRAME TYPE 12

FRAME TYPE 13

INTERLAYER RATED GLASS, **ALUMINUM DOORS ALUMINUM DOORS** \*NOTE: G.C. ALL EXISTING OPENING DIMENSIONS MUST BE VERIFIED IN FIELD

DOOR TYPE H

PAINTED INSULATED HOLLOW METAL W/ 1 HOUR

FIRE RATING W/ INSULATED GLASS, FIRE GLASS

VISION PANEL GLAZING: 9/16" LAMI (.060 SGP

DOOR & HARDWARE SCHEDULES Sheet No:

Scale:

**Drawing Title:** 

6142.00

17 FEB 03 AS NOTED

Description

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HOLLOW METAL FRAME @

HM & HM-I DOORS

ALUMINUM FRAME @

FIN. FLR.

FRAME TYPE 01

HOLLOW METAL FRAME @

HM & HM-I DOORS

ALUMINUM FRAME @

A-6.1


| Manufacturer Abbreviations 1. MK - McKinney               |                                                                |                |              | Doors: 1-130A                                                     | <u>Set: 6.0</u>                                                 |               |               |
|-----------------------------------------------------------|----------------------------------------------------------------|----------------|--------------|-------------------------------------------------------------------|-----------------------------------------------------------------|---------------|---------------|
| 2. PE - Pemko                                             |                                                                |                |              |                                                                   |                                                                 |               |               |
| <ul><li>3. RO - Rockwood</li><li>4. RF - Rixson</li></ul> |                                                                |                |              | <ul><li>6 Hinge (heavy weight)</li><li>2 Exit Device</li></ul>    | T4A3786<br>12 SG NB8710                                         | US26<br>US32  | MK<br>SA      |
| 5. SA - Sargent                                           |                                                                |                |              | 2 Concealed Closer                                                | 91N (PH as required)                                            | 689           | RF            |
| <ul><li>6. SU - Securitron</li><li>7. HS - HES</li></ul>  |                                                                |                |              | 2 Kick Plate                                                      | K1050 10" high 4BE CSK<br>S88BL (Head & Jambs) (perforated at   | US32          | RO            |
| 8. NO - Norton                                            |                                                                |                |              | 1 Gasketing                                                       | 6" as required)                                                 | •             | PE            |
|                                                           |                                                                |                |              | 1 Astragal                                                        | S771C                                                           |               | PE            |
|                                                           | Hardware Schedule                                              |                |              | Doors: 1-114                                                      | <u>Set: 7.0</u>                                                 |               |               |
| oors: 1-100                                               | <b>Set: 1.0</b>                                                |                |              | 3 Hinge (heavy weight)                                            | T4A3786 NRP                                                     | US26          | MK            |
|                                                           |                                                                |                |              | 1 Office Lock                                                     | DG163 SG 28 10G05 LP                                            | US26          | SA            |
| Pivot Set Pivot                                           | 147 BLACK<br>EM19 QC-12 BLACK                                  | 622<br>622     | RF<br>RF     | 1 Door Closer                                                     | CLP7500<br>S88BL (Head & Jambs) (perforated at                  | 689           | NO<br>PE      |
| Concealed Vert Rod Exit                                   | LC SG 43 55 56 AD8410 106                                      | US20D          | SA           | 1 Gasketing                                                       | 6" as required)                                                 |               | PE            |
| Exit Device                                               | BLACK<br>LC SG 43 55 56 AD8410                                 | US20D          |              | Notes:                                                            |                                                                 |               |               |
| Cylinder                                                  | DG1 63 42/ 34 BLACK                                            | US20D          | SA           |                                                                   |                                                                 |               |               |
| Pull                                                      | RM3301-72 (or 96' if reqd) MP<br>BLACK                         | 315            | RO           |                                                                   | <b>Set: 8.0</b>                                                 |               |               |
| Concealed Overhead Holder/Stop  Door Operator             | 6-X36 BLACK                                                    | 622<br>693     | RF<br>NO     | Doors: 1-116, 1-124                                               |                                                                 |               |               |
| Threshold                                                 | 6020 D BLACK<br>273x3AFG MSES10SS                              | 093            | PE           | 3 Hinge (heavy weight)                                            | T4A3786 NRP                                                     | US26          | MK            |
| Gasketing                                                 | By Door Manufacturer                                           |                | 00           | 1 Storeroom Lock                                                  | DG164 SG 28 10G04 LP<br>10-X36                                  | US26          | SA<br>RF      |
| Sweep<br>ElectroLynx Harness                              | 307APK<br>QC-C1500P                                            |                | PE<br>MK     | <ul><li>1 Surface Overhead Stop</li><li>3 Silencer</li></ul>      | 608                                                             | 630           | RO<br>RO      |
| eLynx Door Harness                                        | QC-C*** (Length / Type as Required)                            | )              | MK           |                                                                   | 0                                                               |               |               |
| Operator Switch<br>Power Supply                           | 533 BPS (size & type as required)                              |                | NO<br>SU     | Doors: 1-112, 1-113, 1-115                                        | <u>Set: 9.0</u>                                                 |               |               |
|                                                           | , , , , , , , , , , , , , , , , , , , ,                        |                |              |                                                                   | TA 4 270 C ND D                                                 | TIGO          | ) (II)        |
| NLOCKS EXIT DEVICES AND AC                                | RING NORMAL HOURS PUSHING OU<br>CTIVATES OPERATORS. AFTER HOU  |                |              | <ul><li>3 Hinge (heavy weight)</li><li>1 Storeroom Lock</li></ul> | T4A3786 NRP<br>DG164 SG 28 10G04 LP                             | US26<br>US26  | MK<br>SA      |
| UTTON IS NOT ACTIVE.                                      | JSH BUTTON WILL UNLOCK EXIT A                                  |                |              | 1 Door Closer                                                     | CLP7500                                                         | 689           | NO            |
|                                                           | DEVICE WHICH ACTIVATES ALARM                                   |                |              | 1 Kick Plate                                                      | K1050 10" high 4BE CSK                                          | US32          | RO            |
| ACCESS IS B                                               |                                                                |                |              | 1 Gasketing                                                       | S88BL (Head & Jambs) (perforated at 6" as required)             |               | PE            |
| oors: 1-101                                               | Set: 2.0                                                       |                |              | Doors: 1-103, 1-108, 1-121, 1-12                                  | <u>Set: 10.0</u>                                                |               |               |
| Continuous Hinge                                          | BLFM_HD1                                                       | BLACK          | PE           |                                                                   |                                                                 | <b></b>       |               |
| Exit Device (rim, nightlatch)                             | 16 SG 8804 LC BLACK                                            | US20D          | SA           | <ul><li>3 Hinge (heavy weight)</li><li>1 Office Lock</li></ul>    | T4A3786<br>DG163 SG 28 10G05 LP                                 | US26<br>US26  | MK<br>SA      |
| Cylinder                                                  | DG1 63 42/ 34 BLACK<br>RM3301-72 (or 96' if reqd) MP           | US20D          |              | 1 Door Closer                                                     | 7500                                                            | 689           | NO            |
| Pull                                                      | BLACK                                                          | 315            | RO           | 1 Wall/ Floor Stop                                                | 409/ 446 as required<br>S88BL (Head & Jambs) (perforated at     | US32          | RO            |
| Concealed Closer<br>Door Stop                             | 91N (PH as required) BLACK<br>467                              | 693<br>Black   | RF<br>RO     | 1 Gasketing                                                       | 6" as required)                                                 | •             | PE            |
| Threshold                                                 | 273x3AFG MSES10SS                                              |                | PE           |                                                                   | Set: 11.0                                                       |               |               |
| Gasketing<br>Sweep                                        | By Door Manufacturer 307BPC BLACK POWDER COAT                  |                | 00<br>PE     | Doors: 1-104, 1-104.1                                             | <u> </u>                                                        |               |               |
| •                                                         |                                                                |                |              | 6 Hinge (heavy weight)                                            | T4A3786 NRP                                                     | US26          | MK            |
| otes: OPENING OF DOOR WILL A                              | CIVATE ALARM (CHIME) AT NURS                                   | ES DESK        |              | <ul><li>6 Hinge (heavy weight)</li><li>2 Flush Bolt</li></ul>     | 555 (metal) / 557 (wood)                                        | US26          | RO            |
|                                                           | <b>Set: 3.0</b>                                                |                |              | <ul><li>1 Dust Proof Strike</li><li>1 Classroom Lock</li></ul>    | 570<br>DG164 SG 10G37 LP                                        | US26D<br>US26 | RO<br>SA      |
| oors: 1-129, 1-130                                        |                                                                |                |              | 2 Surface Overhead Stop                                           | 10-X36                                                          | 630           | RF            |
| Pivot Set                                                 | 147 BLACK                                                      | 622            | RF           | 2 Silencer                                                        | 608                                                             |               | RO            |
| Pivot Exit Device                                         | EM19 QC-12 BLACK                                               | 622            | RF           |                                                                   | Set: 12.0                                                       |               |               |
| Cylinder                                                  | SG 43 55 56 8804<br>DG1 63 42/ 34 BLACK                        | US20D<br>US20D | SA<br>SA     | Doors: 1-102, 1-110                                               | <del></del>                                                     |               |               |
| Pull                                                      | RM3301-72 (or 96' if reqd) MP<br>BLACK                         | 315            | RO           | 3 Hinge (heavy weight)                                            | T4A3786                                                         | US26          | MK            |
| Concealed Closer                                          | 91N (PH as required) BLACK                                     | 693            | RF           | 1 Classroom Lock                                                  | DG164 SG 10G37 LP                                               | US26          | SA            |
| Door Stop                                                 | 467                                                            | Black          | RO           | <ul><li>1 Door Closer</li><li>1 Kick Plate</li></ul>              | 7500<br>K1050 10" high 4BE CSK                                  | 689<br>US32   | NO<br>RO      |
| Threshold Gasketing                                       | 273x3AFG MSES10SS By Door Manufacturer                         |                | PE<br>00     | 1 Wall/ Floor Stop                                                | 409/ 446 as required                                            | US32          | RO            |
| Sweep                                                     | 307BPC BLACK POWDER COAT                                       |                | PE           | 1 Gasketing                                                       | S88BL (Head & Jambs) (perforated at 6" as required)             | ,             | PE            |
| ElectroLynx Harness eLynx Door Harness                    | QC-C1500P<br>QC-C*** (Length / Type as Required)               | )              | MK<br>MK     | 1 Door Bottom                                                     | 411ANBL                                                         |               | PE            |
| Power Supply                                              | BPS (size & type as required)                                  | ,              | SU           |                                                                   | Set: 13.0                                                       |               |               |
|                                                           | TY VENDOR. PRESENTING AUTHOI<br>KIT DEVICE ALLOWING ACCESS. EQ |                |              | Doors: 1-125                                                      | <u>======</u>                                                   |               |               |
| EVICE. EMERGENCY ACCESS B                                 |                                                                |                | <del>_</del> | 3 Hinge (heavy weight)                                            | T4A3786                                                         | US26          | MK            |
| LETTING OF DOOR WILL ACTVA                                | La riamidi (Cillivila) AT NURSES DE                            | ~11.           |              | <ul><li>1 Privacy Set</li><li>1 Door Closer</li></ul>             | SG 28 10U65 LP<br>7500                                          | US26<br>689   | SA<br>NO      |
| oors: A-100                                               | <u>Set: 3.1</u>                                                |                |              | 1 Wall/ Floor Stop                                                | 409/ 446 as required                                            | US32          | RO            |
| OO10. 11 <sup>-</sup> 100                                 |                                                                |                |              | 1 Gasketing                                                       | S88BL (Head & Jambs) (perforated at 6" as required)             |               | PE            |
| Continuous Hinge<br>Institutional Lock                    | BLFMHD1<br>DG163 SG 28 10G17 LP                                | BLACK<br>US26D |              |                                                                   | - '                                                             |               |               |
| Concealed Closer                                          | 91N (PH as required) BLACK                                     | 693            | RF           | Doors: 1-105, 1-106, 1-107, 1-11                                  | <u>Set: 14.0</u><br>7, 1-118, 1-119, 1-120, 1-126, 1-127, 1-128 |               |               |
| Door Stop Threshold                                       | 467<br>2009 A PK MSES 10                                       | Black          | RO<br>PE     |                                                                   |                                                                 | 1100          | <i>እ ደ</i> ፲፫ |
| Threshold Gasketing                                       | 2009APK MSES10 By Door Manufacturer                            |                | PE<br>00     | <ul><li>3 Hinge (heavy weight)</li><li>1 Classroom Lock</li></ul> | T4A3786<br>DG164 SG 10G37 LP                                    | US26<br>US26  | MK<br>SA      |
| Rain Guard                                                | 346C                                                           |                | PE           | 1 Concealed Closer                                                | 91N (PH as required)                                            | 689           | RF            |
| Sweep<br>Position Switch                                  | 307APK DPS-M-BK By Security Vendor                             |                | PE<br>SU     | 1 Wall/ Floor Stop                                                | 409/ 446 as required<br>S88BL (Head & Jambs) (perforated at     | US32          | RO            |
| Latch Protector                                           | 320CL                                                          | US32D          | RO           | 1 Gasketing                                                       | 6" as required)                                                 |               | PE            |
| otes:                                                     |                                                                |                |              | <ul><li>1 Door Bottom</li><li>1 Viewer</li></ul>                  | 411ANBL<br>622VC                                                | CRM           | PE<br>RO      |
| oors: 1-110A                                              | Set: 4.0                                                       |                |              | Doors: 1-1054 1 1064 1 1074                                       | <u>Set: 15.0</u><br>, 1-117A, 1-118A, 1-119A, 1-120A, 1-126A, 1 | 1-1274 1      | -128A         |
|                                                           |                                                                |                | D.F.         |                                                                   |                                                                 | •             |               |
| Continuous Hinge<br>Flush Bolt                            | BLFMHD1<br>555 (metal) / 557 (wood)                            | BLACK<br>US26  | PE<br>RO     | <ul><li>3 Hinge (heavy weight)</li><li>1 Privacy Set</li></ul>    | T4A3786<br>SG 28 10U65 LP                                       | US26<br>US26  | MK<br>SA      |
| Dust Proof Strike                                         | 570 (metal) / 55 / (wood)                                      | US26D          | RO           | 1 Wall/ Floor Stop                                                | 409/ 446 as required                                            | US32          | RO            |
| Storeroom Lock                                            | DG164 SG 28 10G04 LP BLACK                                     | US20D          | SA           | 3 Silencer                                                        | 608                                                             |               | RO            |
| Door Closer<br>Threshold                                  | CLP7500<br>2009APK MSES10                                      | 689            | NO<br>PE     |                                                                   |                                                                 |               |               |
| Gasketing                                                 | By Door Manufacturer                                           |                | 00           |                                                                   |                                                                 |               |               |
| Rain Guard<br>Sweep                                       | 346C<br>307APK                                                 |                | PE<br>PE     |                                                                   |                                                                 |               |               |
| Latch Protector                                           | 320CL                                                          | US32D          |              |                                                                   |                                                                 |               |               |
| oors: 1-109, 1-111                                        | Set: 5.0                                                       |                |              |                                                                   |                                                                 |               |               |
| Continuous Hinge                                          | BLFM_HD1                                                       | BLACK          | PE           |                                                                   |                                                                 |               |               |
| Storeroom Lock                                            | DG164 SG 28 10G04 LP BLACK                                     | US20D          | SA           |                                                                   |                                                                 |               |               |
| Door Closer<br>Threshold                                  | CLP7500<br>2009APK MSES10                                      | 689            | NO<br>PE     |                                                                   |                                                                 |               |               |
| Gasketing                                                 | By Door Manufacturer                                           |                | 00           |                                                                   |                                                                 |               |               |
|                                                           | 346C                                                           |                | PE           |                                                                   |                                                                 |               |               |
| Rain Guard<br>Sweep                                       | 307APK                                                         |                | PE           |                                                                   |                                                                 |               |               |




**BILLINGSLEY FACILITY BUILDING 4** 11,100 BILLINGSLEY ROAD WALDORF, MARYLAND 220602



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Project Type

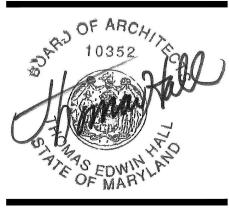Alteration Remodel

New Addition New Construction

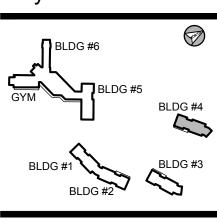**Drawing Status** 

Design Phase Not For Construction

For Pricing For Permit

Revision For Construction

| No.       | Date       | Description  |
|-----------|------------|--------------|
| <b>10</b> | 06/03/2016 | REVISION #10 |
| $\Delta$  | 07/07/2016 | REVISION #11 |
| 12        | 07/27/2016 | REVISION #12 |
| 13        | 09/16/2016 | REVISION #13 |
| 14        | 01/06/2017 | REVISION #14 |
| 14.1      | 02/03/2017 | ADDENDUM #1  |
|           |            |              |

Job No: 6142.00 Drawn By:

Date: Scale: 17 FEB 03 AS NOTED Drawing Title:

DOOR & HARDWARE SCHEDULES

Sheet No:

BILLINGSLEY BUILDING 4